ADDENDUM TO SPECIFICATIONS ENTITLED 'SPECIFICATIONS FOR RE-BID JONES PSC ROOF REPLACEMENT UNIVERSITY OF SOUTH CAROLINA COLUMBIA, SOUTH CAROLINA PROJECT NO. H27-6094-Z"

ADDENDUM NO. 1 September 17, 2015

The Specifications and Drawings contained in the project manual entitled "Specifications for Re-Bid Jones PSC Roof Replacement, University of South Carolina, Project No. H27-6094-Z" are amended as follows:

GENERAL

1. The sign in sheet to the Pre-bid Meeting held September 10, 2015 is attached.

SPECIFICATIONS

- 1. In Section 06100 ROUGH CARPENTRY, delete paragraphs 3.6 and 3.7 in their entirety.
- 2. In Section 07000 ROOFING PREPARATION, add the following to paragraph 3.8:
 - E. Fasten stair treads to curb using Simpson H2.5A hurricane clips or approved equal.
 - F. Secure hurricane clips using #8 stainless steel screws 11/4" or longer.
- 3. In Section 07552 SBS-MODIFIED BITUMINOUS MEMBRANE ROOFING, delete paragraph 2.3.A in its entirety and replace with the following:
 - A. Base Ply: ASTM D 5147 and D 6163, Type II, Grade S, SBS-modified asphalt sheet (or ASTM D6164, Type I, Grade S, Polyester) with glass fiber mat reinforcing, suitable for application method specified.
- 4. In Section 07552 SBS-MODIFIED BITUMINOUS MEMBRANE ROOFING, delete paragraph 2.3.B and sub-paragraph 1 in its entirety and replace with the following:
 - A. Cap Sheet: ASTM D 5147 and D 6163, Type II, Grade G, SBS-modified asphalt sheet ASTM D6164, Type I, Grade S, Polyester, with glass fiber mat reinforcing, granular surfaced, suitable for application method specified and as follows:
 - Granule Color: White.
- 5. In section 07552 SBS-MODIFIED BITUMINOUS MEMBRANE ROOFING, delete paragraph 2.4.A in its entirety and replace with the following:
 - A. Backer Sheet: ASTM D 6163 (or ASTM D 6164, Grade S, Polyester), Grade S, Type I, glass-fiber-reinforced, SBS-modified asphalt sheet; smooth surfaced; suitable for application method specified.
- 6. In section 07552 SBS-MODIFIED BITUMINOUS MEMBRANE ROOFING, delete paragraph 2.4.B and sub-paragraph 1 in its entirety and replace with the following:

- A. Flashing Sheet: ASTM D 6163 or ASTM D 6164, Grade G, Type I, polyesterreinforced, SBS-modified asphalt sheet; granular surfaced; suitable for torch application method, and as follows:
 - 1. Granular surfaced.

DRAWINGS

Delete Drawings T 100, R-100, R-101, R-200, R-201, R-202, R-203, R-204, R-205 and R-206 in their entirety and replace with attached drawings T-100 (Addendum No. 1), R-100 (Addendum No. 1), R-101 (Addendum No. 1), R-200 (Addendum No. 1), R-201 (Addendum No. 1), R-202 (Addendum No. 1), R-203 (Addendum No. 1). R-204 (Addendum No. 1), R-205 (Addendum No. 1) and R-206 (Addendum No. 1).

END OF ADDENDUM

Enclosures: T-100 (Addendum No. 1)

R-100 (Addendum No. 1) R-101 (Addendum No. 1) R-200 (Addendum No. 1), R-201 (Addendum No. 1) R-202 (Addendum No. 1) R-203 (Addendum No. 1) R-204 (Addendum No. 1)

R-204 (Addendum No. 1) R-205 (Addendum No. 1) R-206 (Addendum No. 1) Pre-bid Sign in sheet

University of South Carolina Non Mandatory Pre Bid Sign In Sheet Columbia, South Carolina

Project Name: Project Number: Pre Bid Date & Time:

RE BID PSC Roof Replacement H27-6094-Z

September 10, 2015 @ 10:00 AM

| S W M B E | S W M B E | S W M B E | S W M B E | S W M B E | SWMBE | S W M B E | S W M B E | SWMBE | SWMBE Contractor Indicate Below |
|---|------------------------------|---------------------------------------|---|--|---------------------------------|--------------------------------|---|--|---------------------------------------|
| CARTER Wallace | DAMANEVILLE | McSwain Miles | Steve MARAN Jr | DAVID SNEED | Ivino kimb eld southern Roding | John A. Gann | Ed Busks | Justin Luhite | Name |
| CARTER Wallace Southwar CRANCe Lexington SC | ADVASCALN/FG/ROOFING | Rostro | Warsleeting | TESTA America | | CCB | CCR | ASC /soprens | Company Name |
| 2 | 12525×19187 100 No. 1909 150 | 1345 N. Pike East Sumter St. 29150 | 1416 FARTIER 120 | 12012 Independent | 785 Nuth Wife Dr. (863) 773-822 | | | 9317 - Forsyth Book D. Charlotte, NC | Address |
| 8219 | ao | 85-775- | 35-786-4610 | 104-882-1500 | 223-511 (503) | 843-369-4101 | 843 369-41 | 1647-854(106) | Phone # |
| carter@ Southwaycrane. | -0400 dana@agussealsc.com | ratio OSC. Vr. com | 803-786-400 Steve Jre Wattsrooting. Com | Inclim Tripl, DC 704-882-1200 of succel of technology on con | tr: ppe Souther roofing coun | 3-369-4101 jouann e scoust net | 843 369-4/01 jobantes Decestal commosil | (204) 458-6734 Vostino Conferescentarios con | Email |

^{****}By signing this sheet you agree to receive information electronically.

Non Mandatory Pre Bid Sign In Sheet **University of South Carolina** Columbia, South Carolina

RE BID PSC Roof Replacement H27-6094-Z

Project Name: Project Number: Pre Bid Date & Time:

September 10, 2015 @ 10:00 AM

| S W M B E | S W M B E | SWMBE | S W M B E | SWMBE | SWMBE | .5 W M B E | S W M B E | S W M B E | SWMBE Contractor indicate Below |
|-----------|-----------|-------|-----------|-------|------------------------------------|-----------------------------------|--|-----------------------------|---------------------------------------|
| | | | | | Bale Branham | Who | Kenth Carpellul. | VANCINO 6 Some | Name |
| | B | | | | USC | | Tessecon/ shellow | Nations Roof | Company Name |
| | | | | | m re | 1436 reenc st | 2010 Stock Rd | Charlotte NC | Address |
| | | | | | 777.1288 | 111.3596 | 7047136855 | 826-616-190 | Phone # |
| | | | | | 1711.1288 Joranhamd & Fmc. Sc. Pdu | 1997. 3596 jbrookine fmc. sc. edu | 7136855 Killagarellist D. Hornson, Com | 8 fsoria D nations root com | Email |

^{****}By signing this sheet you agree to receive information electronically.

UNIVERSITY of SOUTH CAROLINA



RE-BID USC JONES PSC ROOF REPLACEMENT PROJECT


PROJECT No.: H27-6094-Z

ADDENDUM No. 1: REVISED BID DOCUMENT SET

701 MAIN STREET COLUMBIA, SOUTH CAROLINA, 29208

| VICINITY MAP | INDE | X OF DRAWINGS | LOCATION MAP | | |
|--|-----------|--|---|--|--|
| Sesquicentennial State Park | SHEET NO: | SHEET NAME: | Greene St. | | |
| Dentsville Woodfield | T-100 | COVER SHEET | Per Center for the Arts David R. Coker Life Earth and Sciences Water Sciences Building | | |
| Seven Oaks St Andrews St Andrews St Andrews St Andrews | R-100 | ROOF PLAN | Greene Street United Methodist United Methodist Greene Street United Methodist Greene Street Sciences Center Blake, Pharmit | | |
| Salusta Mirror 176 | R-101 | ROOF PLAN: FIELD, CORNER AND PERIMETER | ne St | | |
| 277 (555) Forest Acres (12) | R-200 | ROOF DETAILS | (48) University of South | | |
| Columbia Tel Devine St Tel Tel Tel Tel Tel Tel Tel Te | R-201 | ROOF DETAILS | Darla Moore School of Business | | |
| Columbia (48) (5) (6) (7) (7) (8) (9) (9) (18 | R-202 | ROOF DETAILS | PROJECT DEVINE LIMOUSINE DEVINE LIMOUSINE PROJECT Firehouse Subs (II) Al-Amir on Main | | |
| Cayce Caybing | R-203 | ROOF DETAILS | SITE Moe's Southwest Grill ATM (\$) | | |
| Springdale (2089) | R-204 | ROOF DETAILS | Special Moving Service Courtyard Columbia Carolina Coliseum Carolina Coliseum | | |
| Metropolitan-Airport (768) (48) | R-205 | ROOF DETAILS | Yogurt and Smoothies also | | |
| E Steele Rd 20 To | R-206 | REMOVALS | Parks S | | |
| Pine Ridge (302) Pine Ridge Hopkin | | | Wspa TV Columbia Bureau | | |




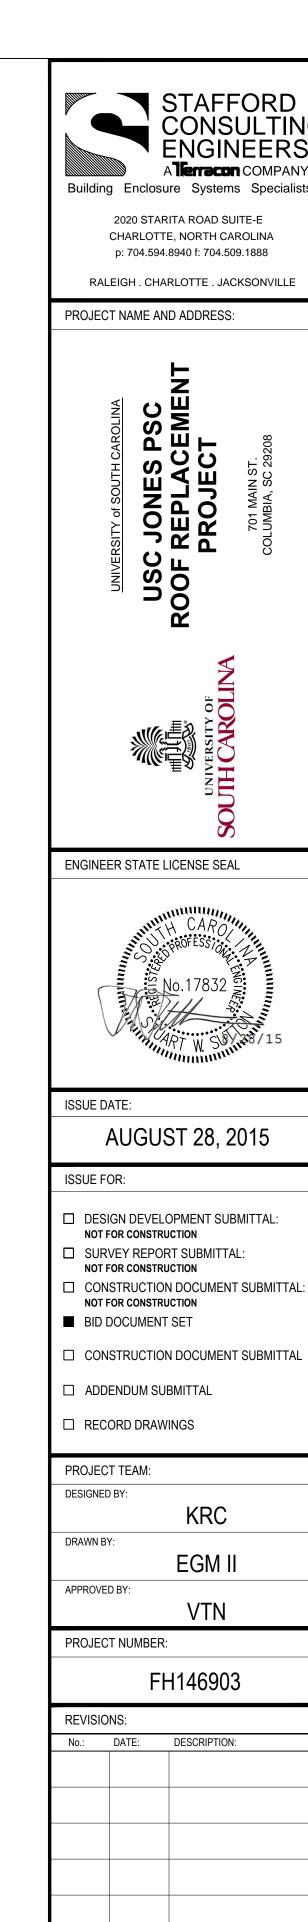

TITLE SHEET:

COVER SHEET

T-100

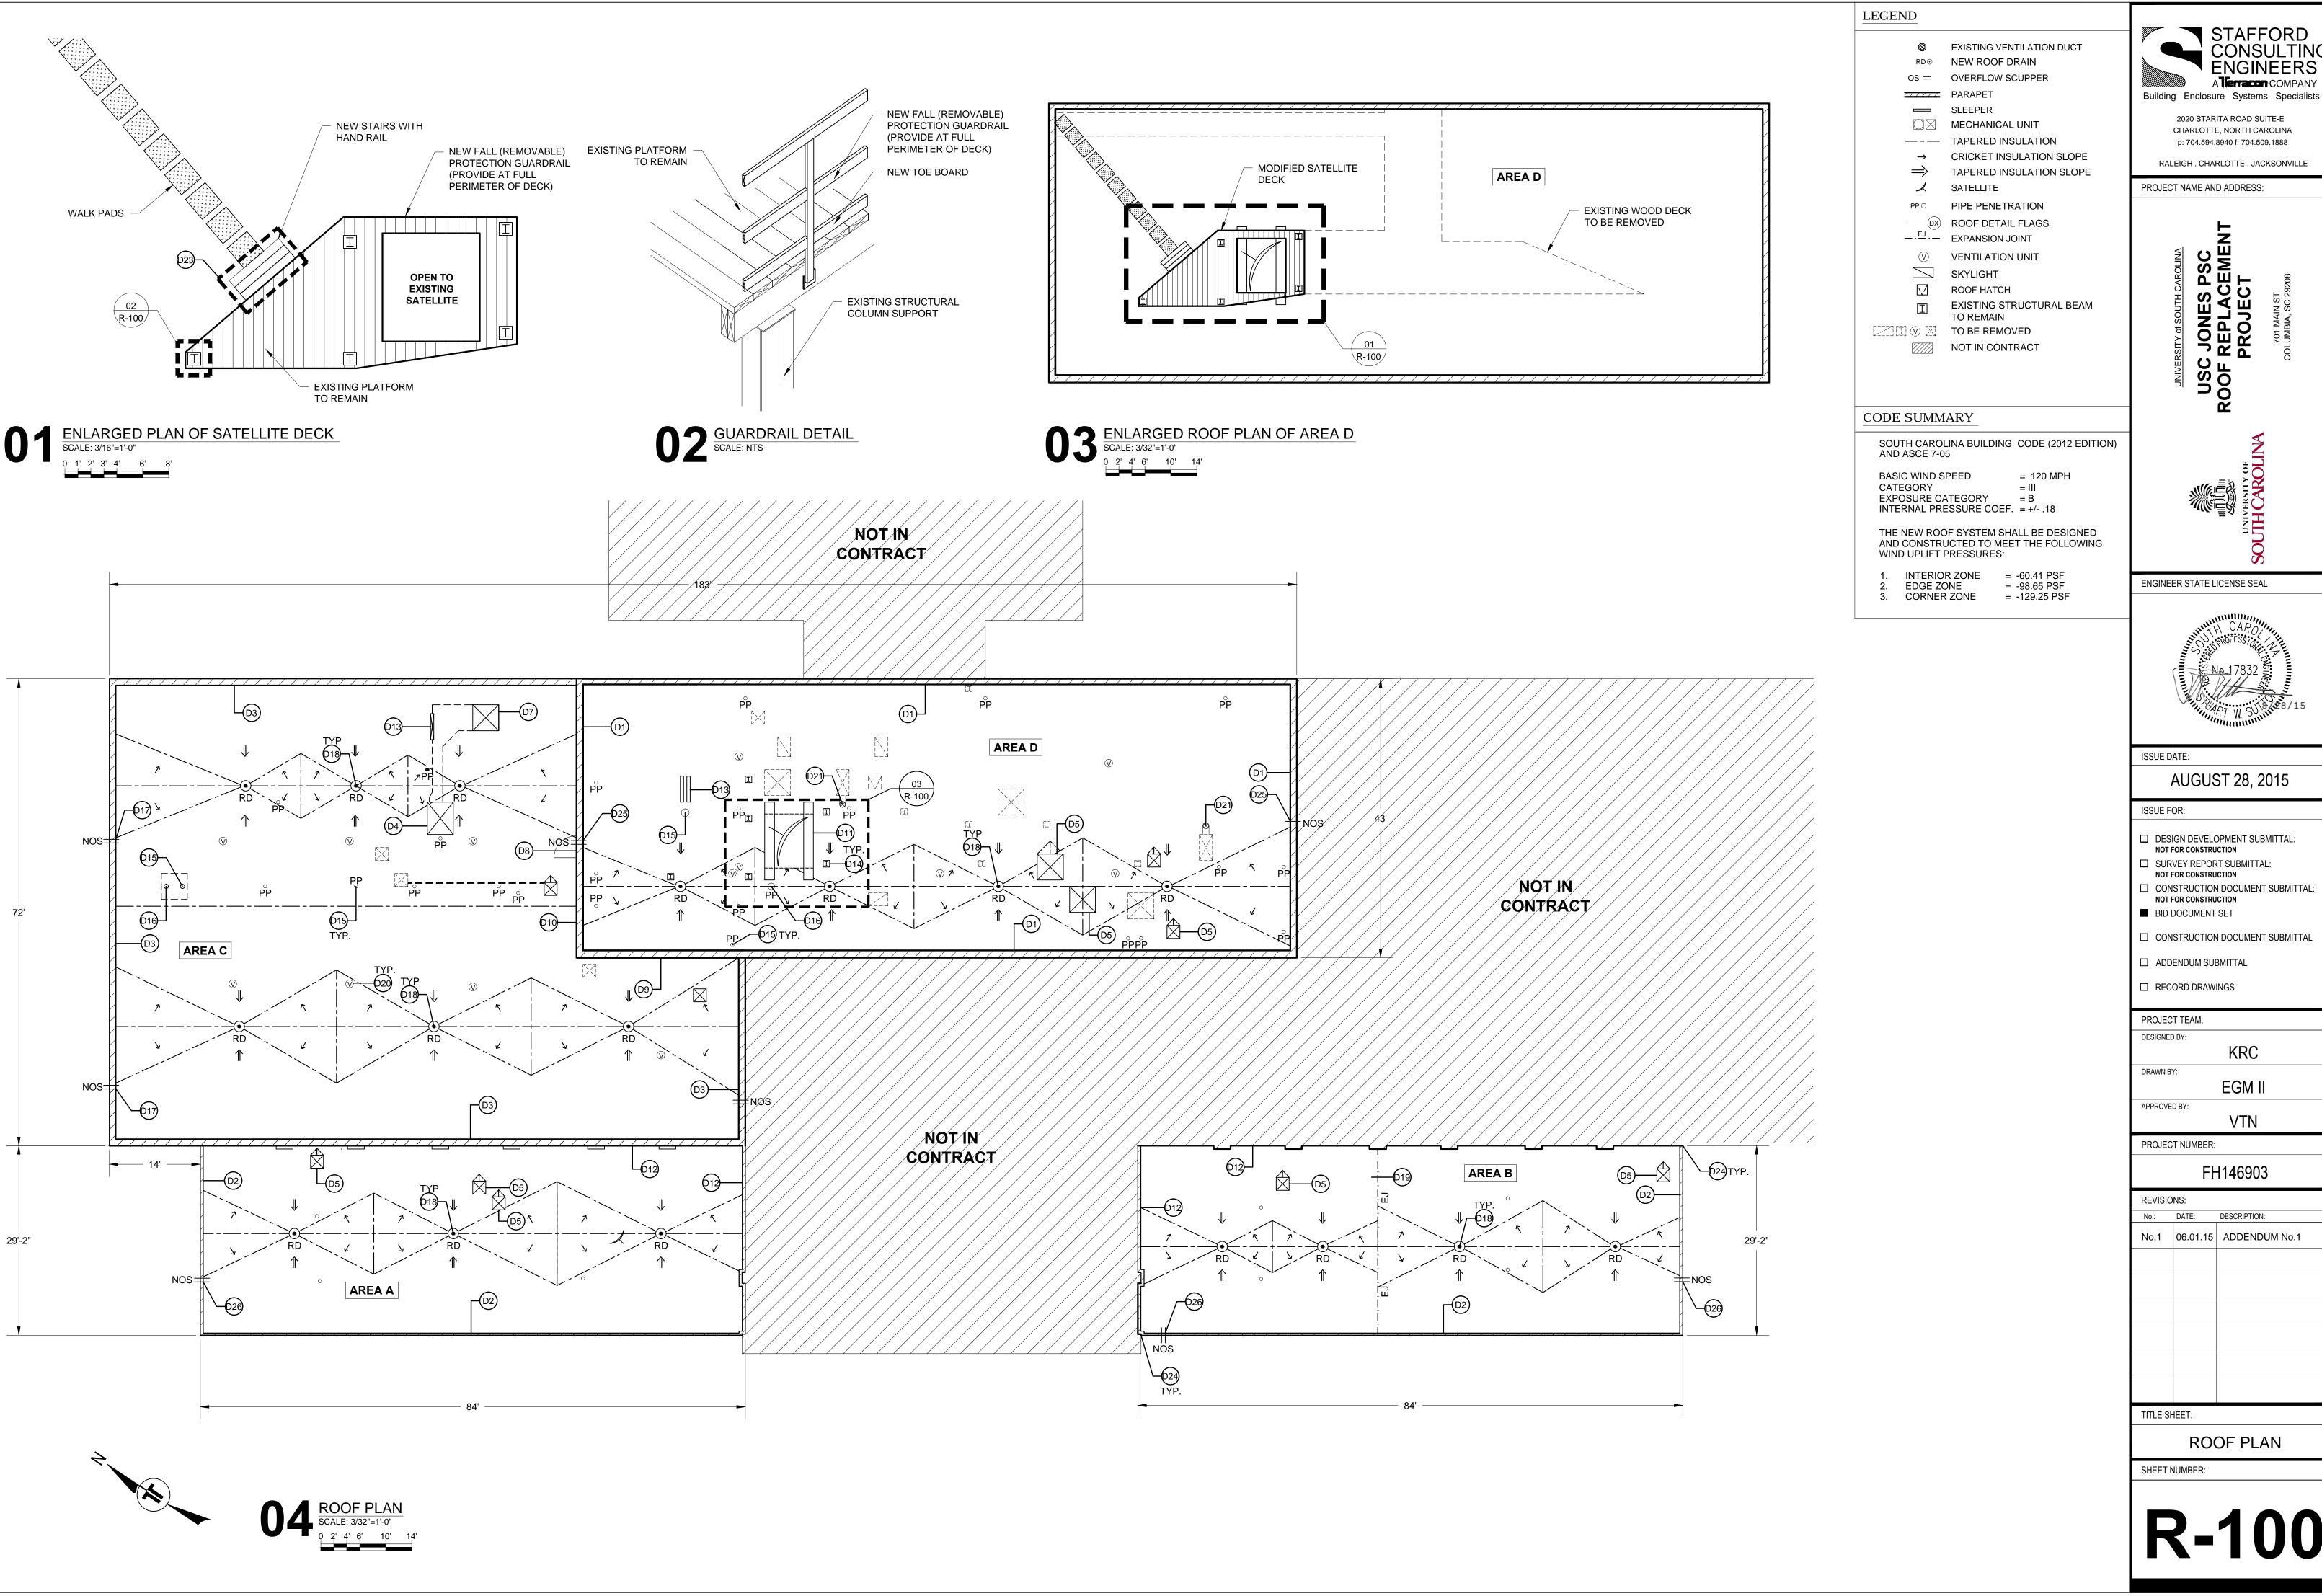

STAFFORD CONSULTING ENGINEERS A**llerracon** COMPANY

2020 STARITA ROAD SUITE-E CHARLOTTE, NORTH CAROLINA p: 704.594.8940 f: 704.509.1888

RALEIGH . CHARLOTTE . JACKSONVILLE

PROJECT NAME AND ADDRESS:

USC JONES PSC ROOF REPLACEMEN PROJECT

ENGINEER STATE LICENSE SEAL



ISSUE DATE:

AUGUST 28, 2015

☐ DESIGN DEVELOPMENT SUBMITTAL: NOT FOR CONSTRUCTION ☐ SURVEY REPORT SUBMITTAL:

NOT FOR CONSTRUCTION ☐ CONSTRUCTION DOCUMENT SUBMITTAL

NOT FOR CONSTRUCTION

☐ CONSTRUCTION DOCUMENT SUBMITTAL

☐ ADDENDUM SUBMITTAL

☐ RECORD DRAWINGS

PROJECT TEAM: DESIGNED BY:

KRC

EGM II

VTN

PROJECT NUMBER:


FH146903

REVISIONS:

No.1 06.01.15 ADDENDUM No.1

ROOF PLAN

SHEET NUMBER:

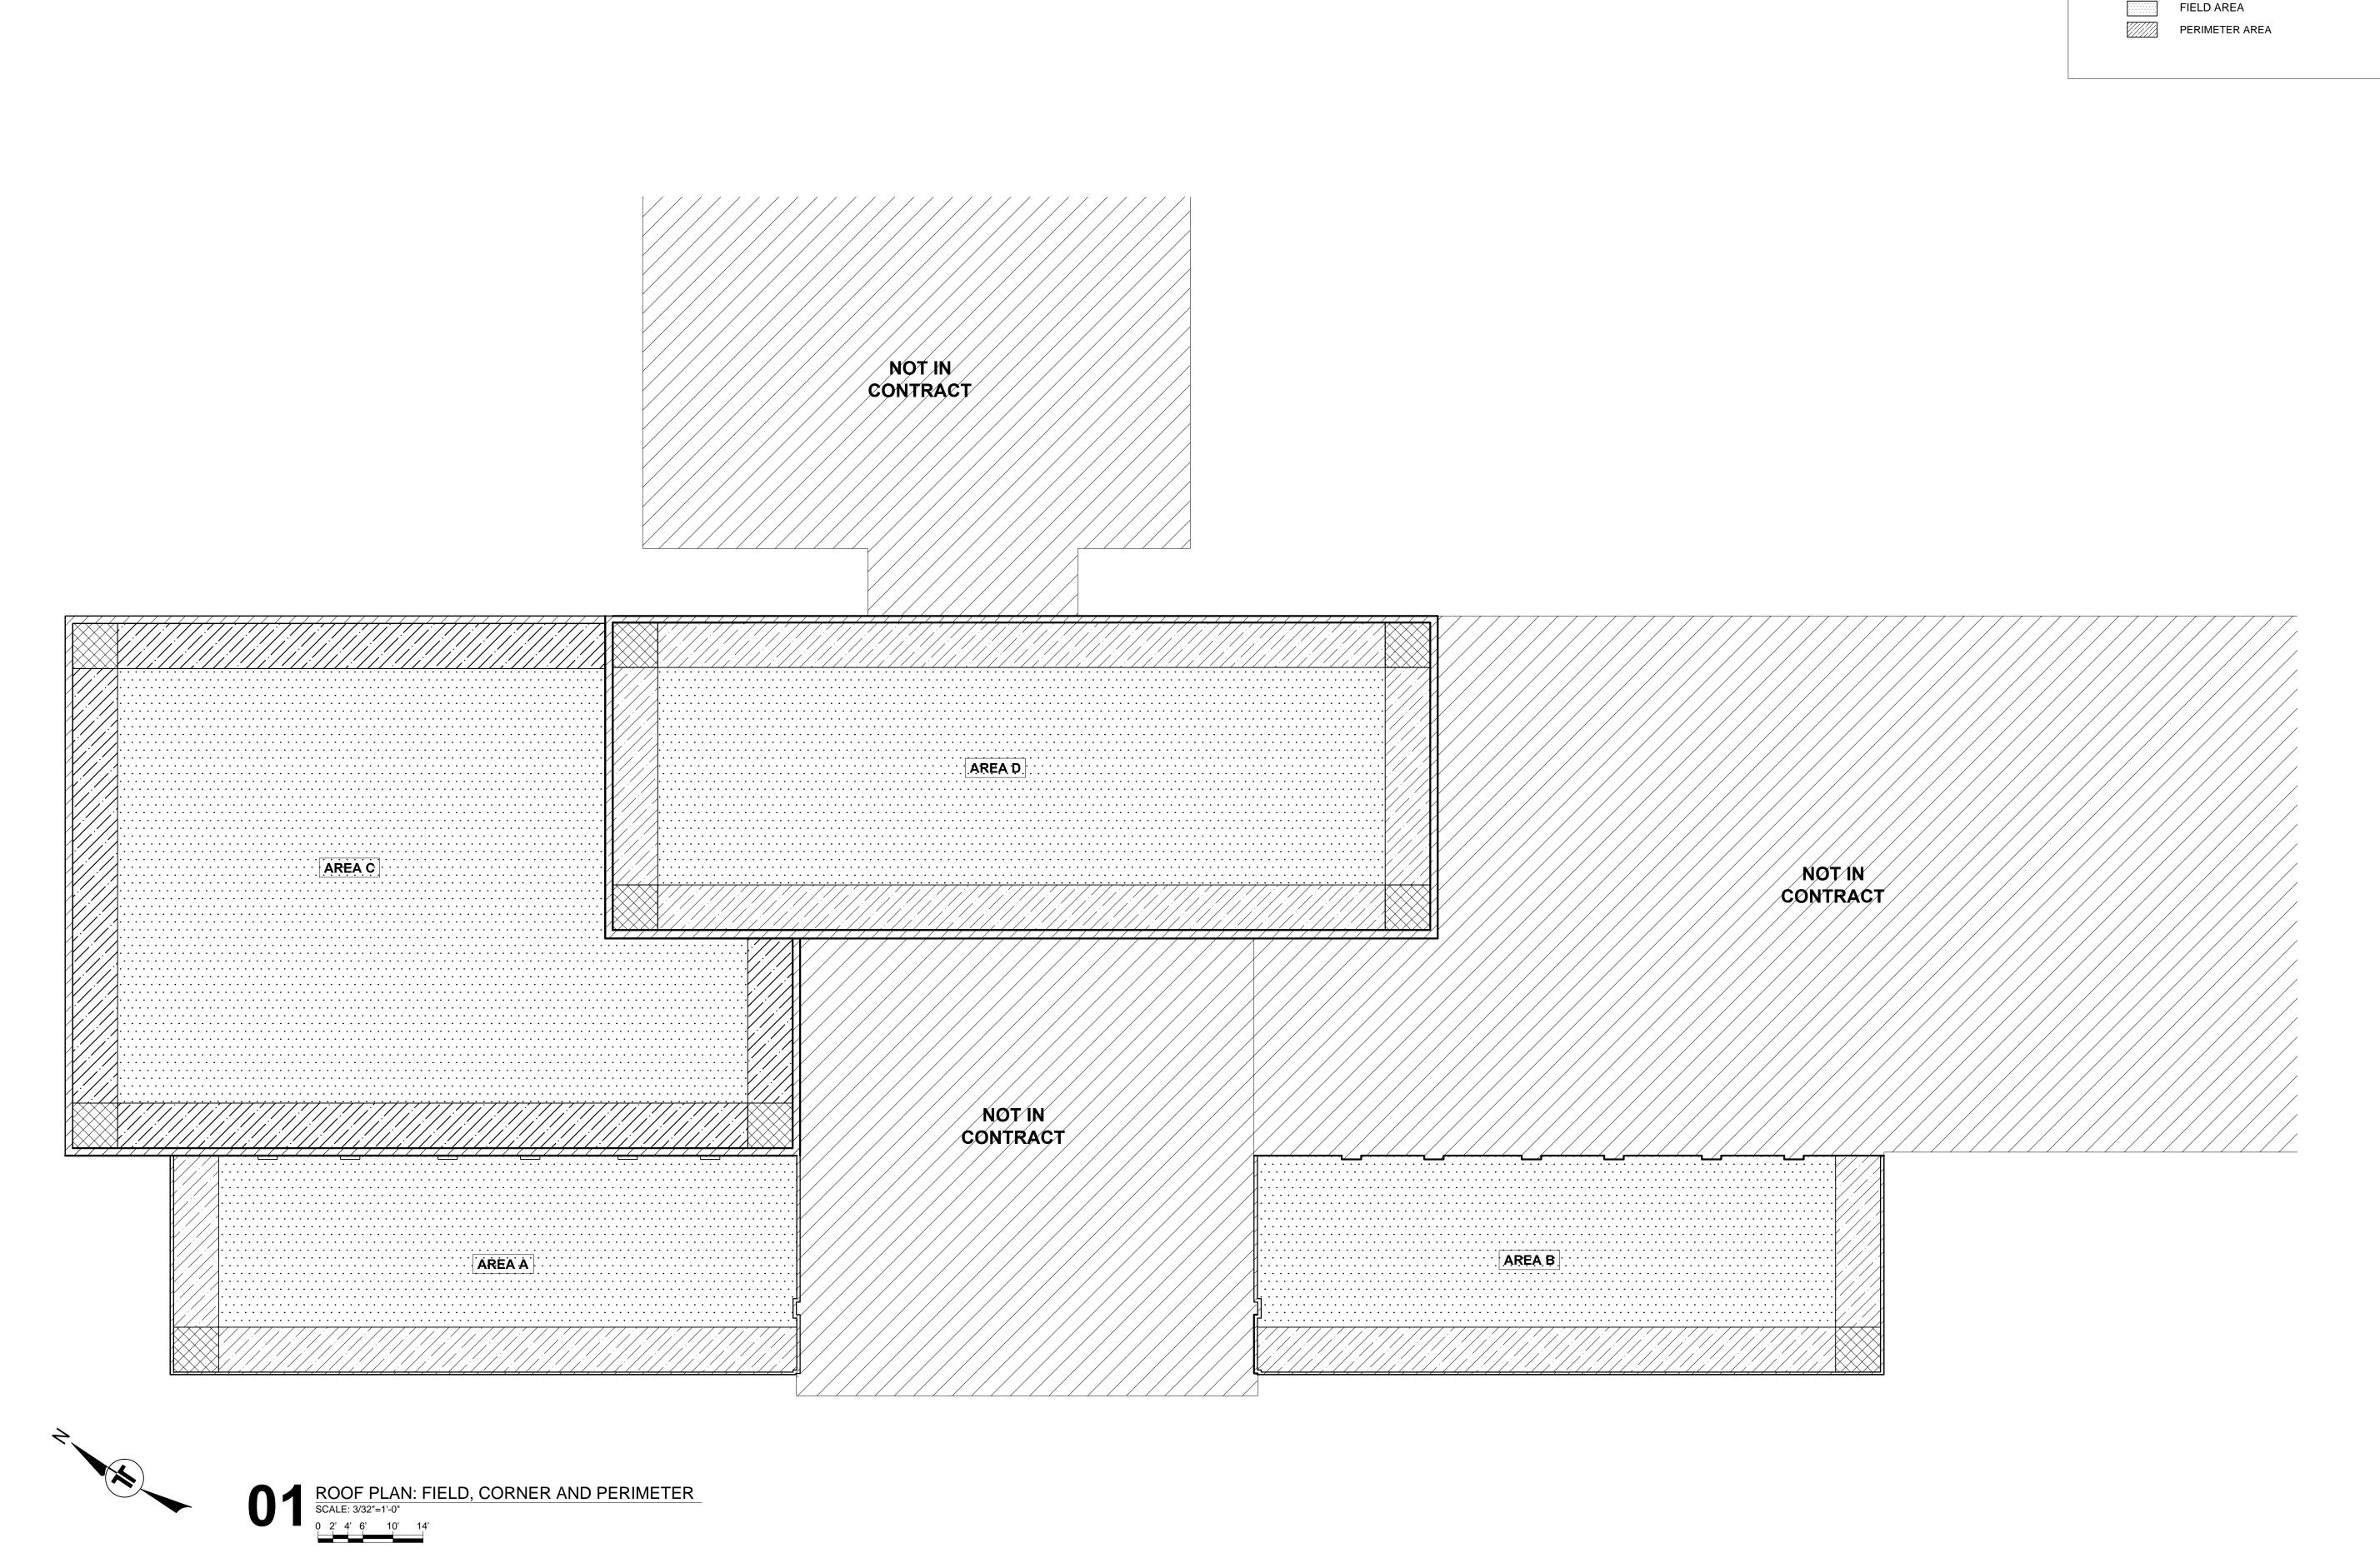

STAFFORD CONSULTING ENGINEERS

Alerracon COMPANY

Building Enclosure Systems Specialists

LEGEND

CORNER AREA

2020 STARITA ROAD SUITE-E CHARLOTTE, NORTH CAROLINA p: 704.594.8940 f: 704.509.1888

RALEIGH . CHARLOTTE . JACKSONVILLE

PROJECT NAME AND ADDRESS:

JSC JONES PSC
OF REPLACEMENT
PROJECT



ENGINEER STATE LICENSE SEAL



ISSUE DATE:

AUGUST 28, 2015

ISSUE FOR:

- DESIGN DEVELOPMENT SUBMITTAL: NOT FOR CONSTRUCTION
- ☐ SURVEY REPORT SUBMITTAL: NOT FOR CONSTRUCTION☐ CONSTRUCTION DOCUMENT SUBMITTAL:
- □ CONSTRUCTION DOCUMENT SUBMITT
 NOT FOR CONSTRUCTION
 BID DOCUMENT SET
- ☐ CONSTRUCTION DOCUMENT SUBMITTAL
- ☐ ADDENDUM SUBMITTAL

☐ RECORD DRAWINGS

PROJECT TEAM:

DRAWN BY:

DESIGNED BY:

EGM II

ROVED BY:

APPROVED BY:

PROJECT NUMBER:

FH146903

VTN

REVISIONS:

 No.:
 DATE:
 DESCRIPTION:


 No.1
 06.01.15
 ADDENDUM No.1


TITLE SHEET:


TITLE SHEET:


ROOF PLAN: FIELD, CORNER AND PERIMETER

SHEET NUMBER:

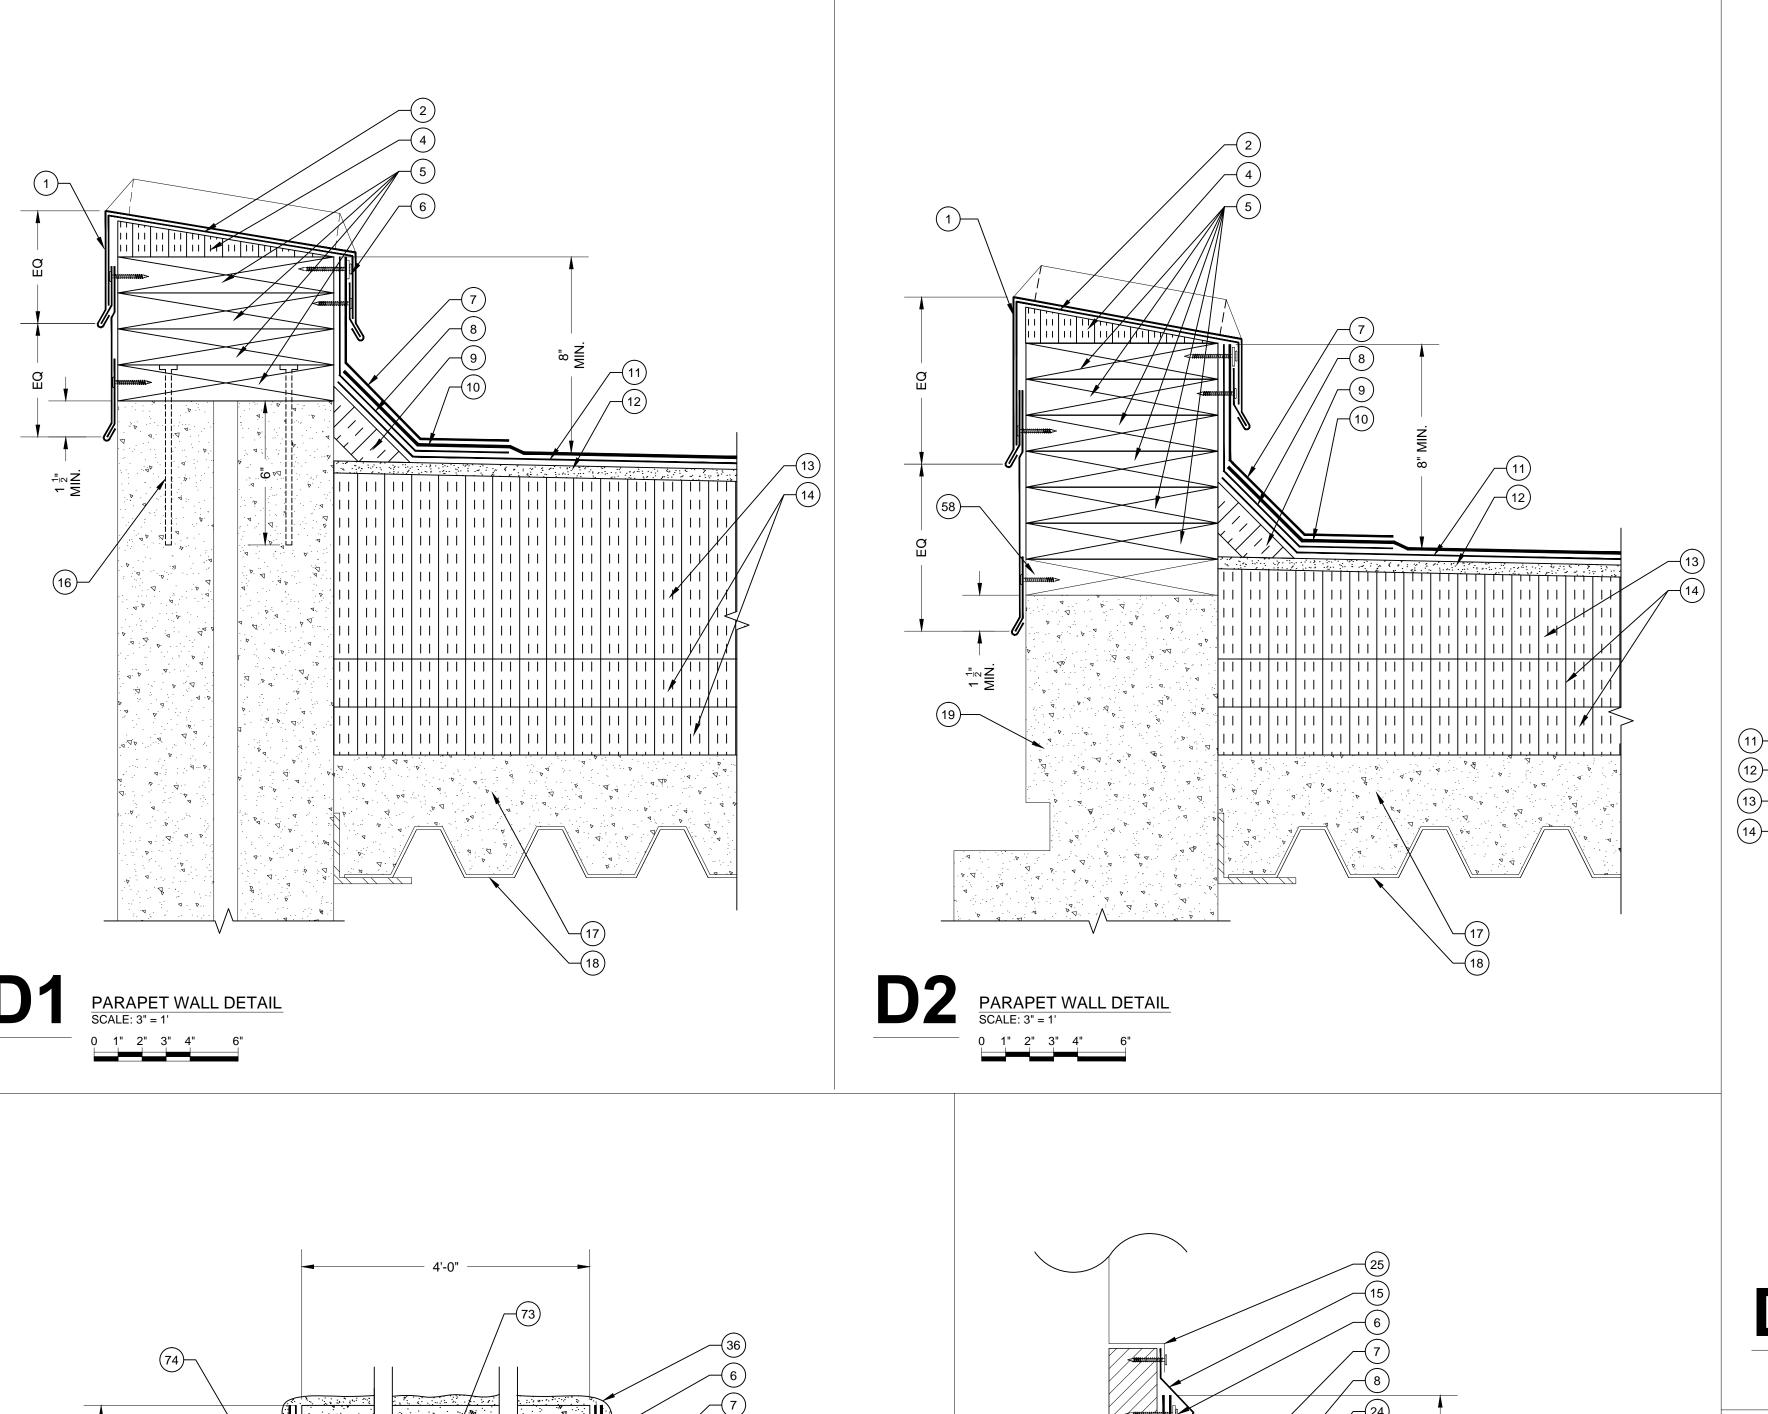

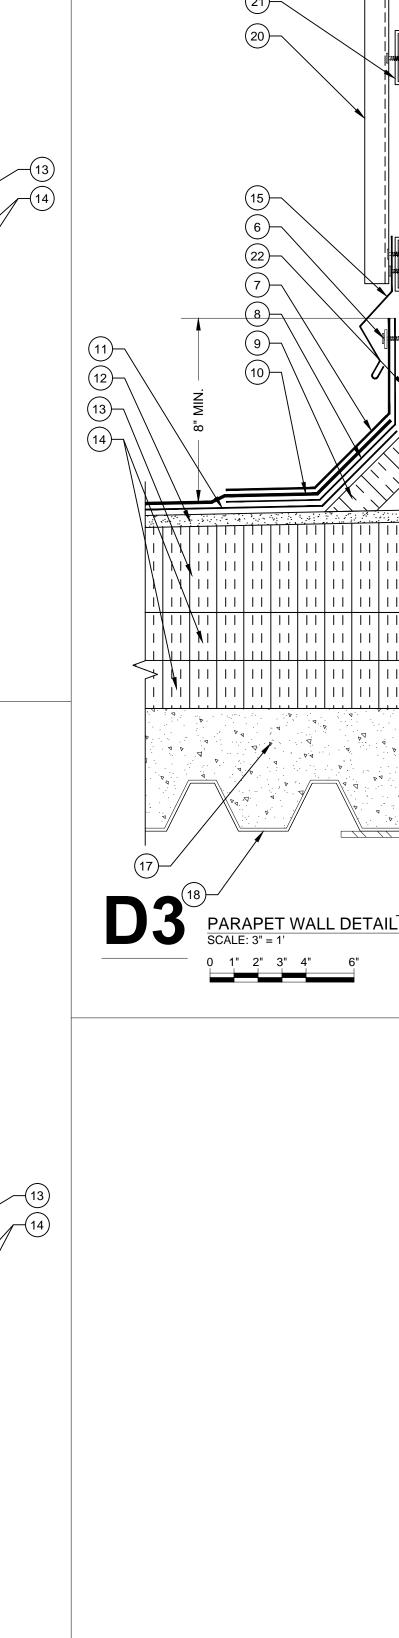

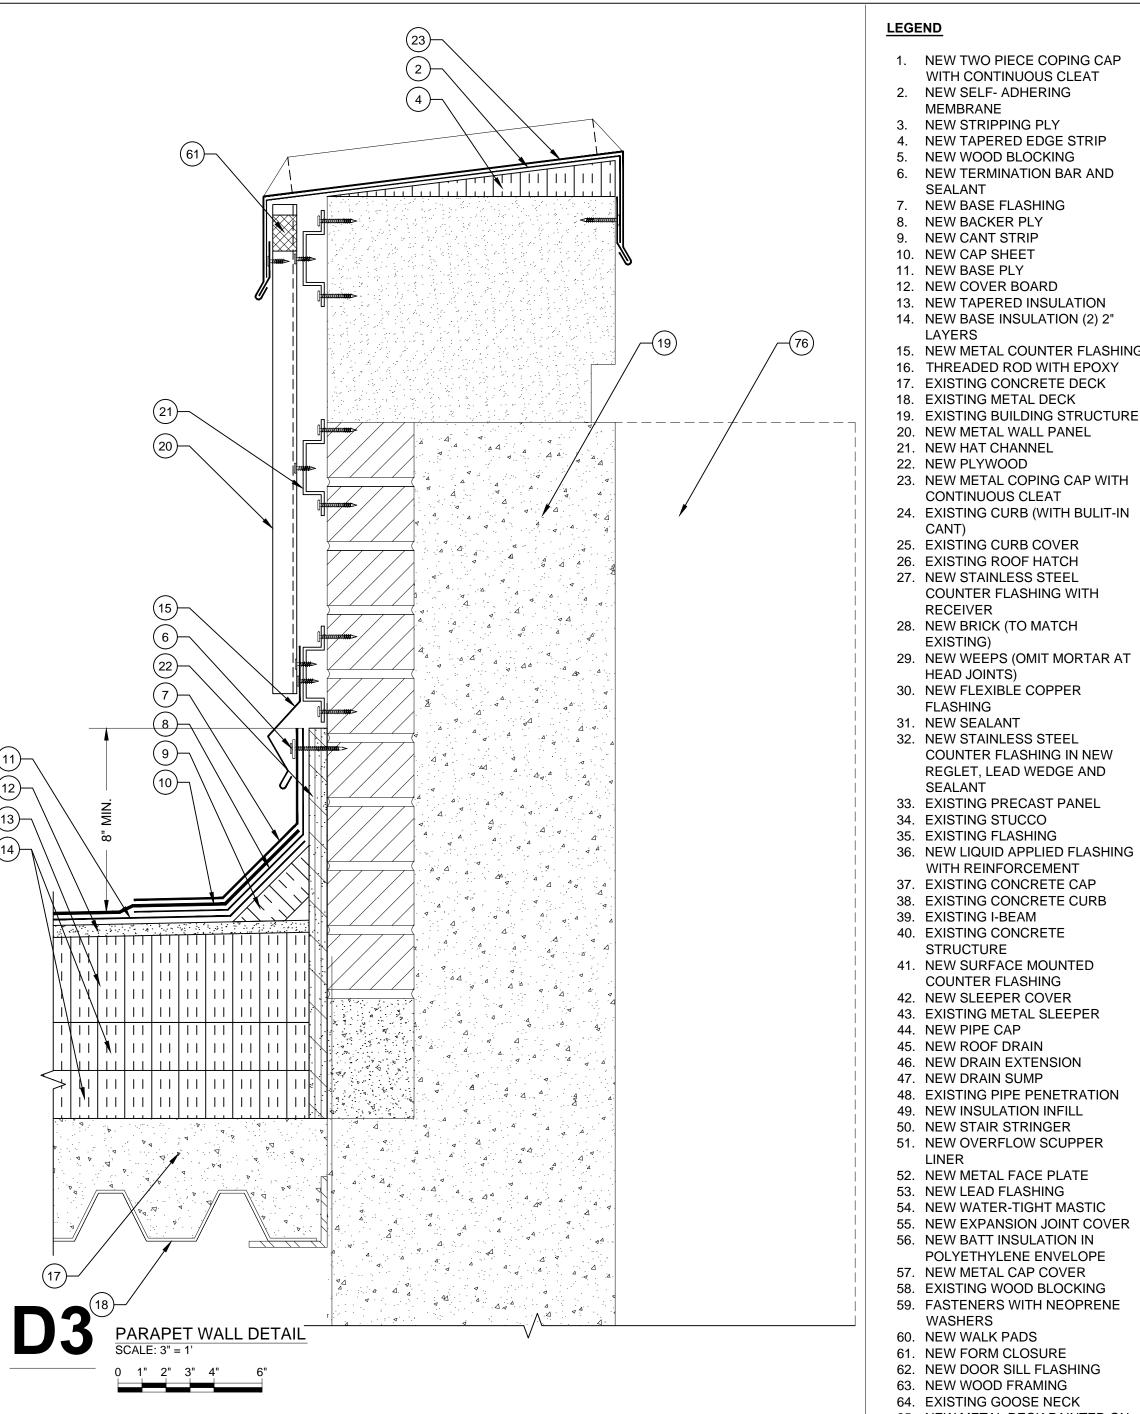

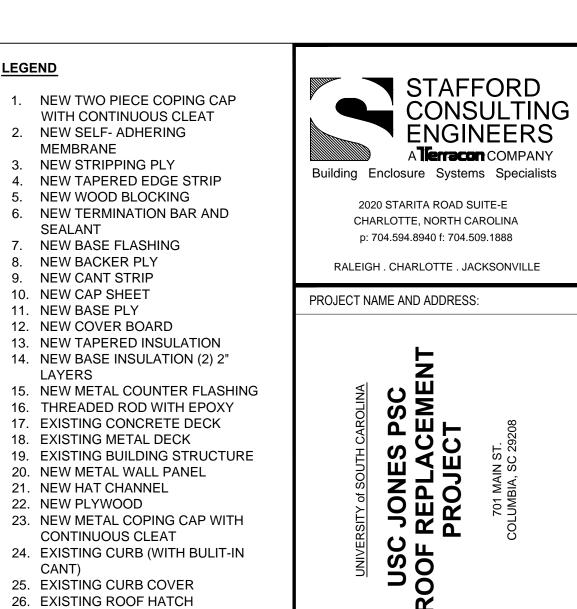

ENGINEER STATE LICENSE SEAL



ISSUE DATE:

AUGUST 28, 2015

☐ CONSTRUCTION DOCUMENT SUBMITTAL:

☐ CONSTRUCTION DOCUMENT SUBMITTAL

KRC

EGM II

VTN

FH146903

ISSUE FOR: DESIGN DEVELOPMENT SUBMITTAL:

☐ SURVEY REPORT SUBMITTAL:

NOT FOR CONSTRUCTION

NOT FOR CONSTRUCTION

NOT FOR CONSTRUCTION

☐ ADDENDUM SUBMITTAL

☐ RECORD DRAWINGS

PROJECT TEAM:

DESIGNED BY:

DRAWN BY:

APPROVED BY:

PROJECT NUMBER:

■ BID DOCUMENT SET

52. NEW METAL FACE PLATE 53. NEW LEAD FLASHING 54. NEW WATER-TIGHT MASTIC

COUNTER FLASHING WITH

COUNTER FLASHING IN NEW REGLET, LEAD WEDGE AND

WITH REINFORCEMENT

COUNTER FLASHING

RECEIVER

EXISTING)

FLASHING

SEALANT

STRUCTURE

HEAD JOINTS)

55. NEW EXPANSION JOINT COVER 56. NEW BATT INSULATION IN POLYETHYLENE ENVELOPE

57. NEW METAL CAP COVER 58. EXISTING WOOD BLOCKING 59. FASTENERS WITH NEOPRENE

WASHERS 60. NEW WALK PADS

61. NEW FORM CLOSURE 62. NEW DOOR SILL FLASHING 63. NEW WOOD FRAMING 64. EXISTING GOOSE NECK

65. NEW METAL DECK PAINTED ON INTERIOR TO MATCH EXISTING 66. NEW MIDSPAN SUPPORT 67. NEW 2" x3" 20 ga. CLIPS (4) 68. NEW ³/₄" CONCRETE LAG

69. EXISTING PLYWOOD 70. NEW BATT INSULATION 71. NEW $\frac{1}{4}$ " STEEL Z ANGLE 72. NEW METAL DECKING

73. NEW CONCRETE CURB 74. EXISTING CONCRETE CURB 75. PRE-MANUFACTURED SLEEPER 76. EXISTING PRE CAST CONCRETE

(BEYOND) 77. NEW BRACKET

78. NEW COPING CAP WITH CONTINUOUS CLEAT 79. EXISTING VENTILATION DUCT


REVISIONS:


No.: DATE: DESCRIPTION: No.1 06.01.15 ADDENDUM No.1

TITLE SHEET: **ROOF DETAILS**


SHEET NUMBER:


R-200

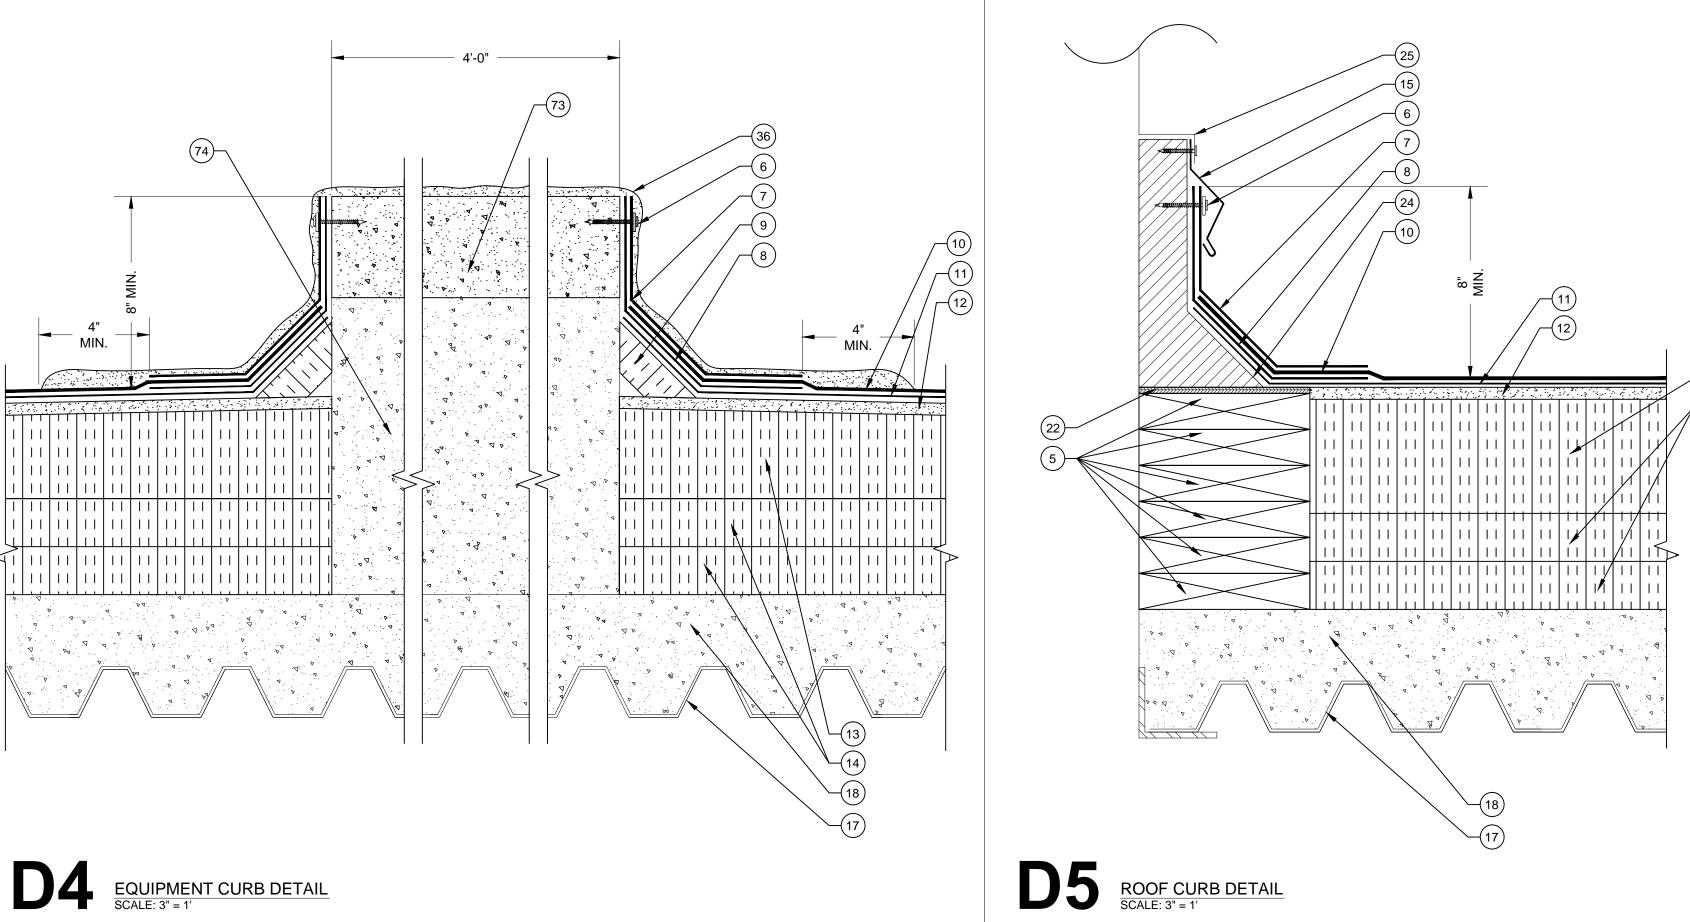


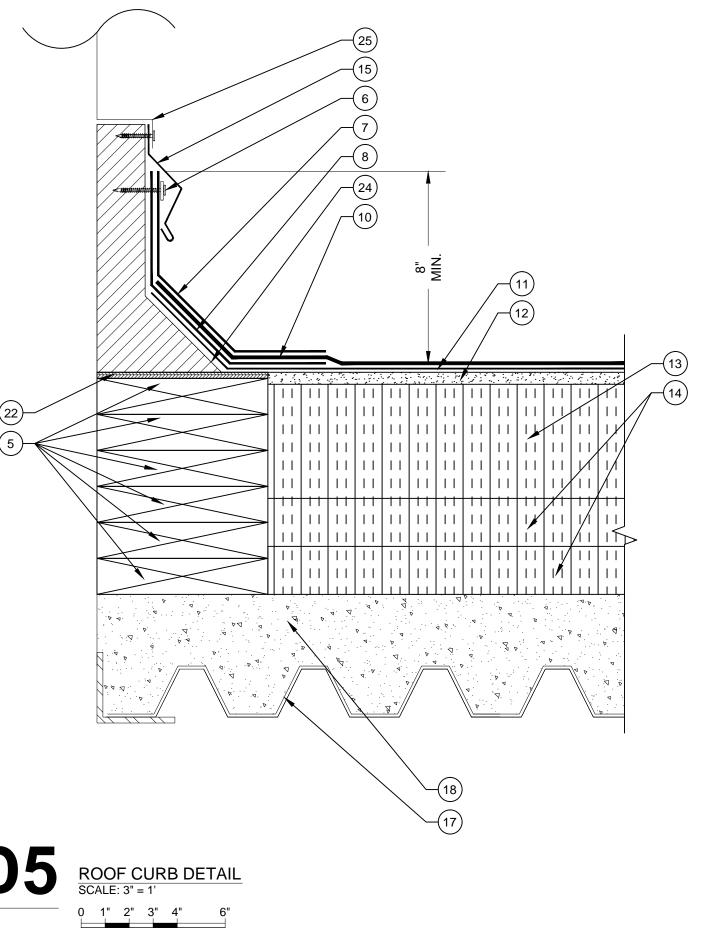


NOT IN USE SCALE: NTS

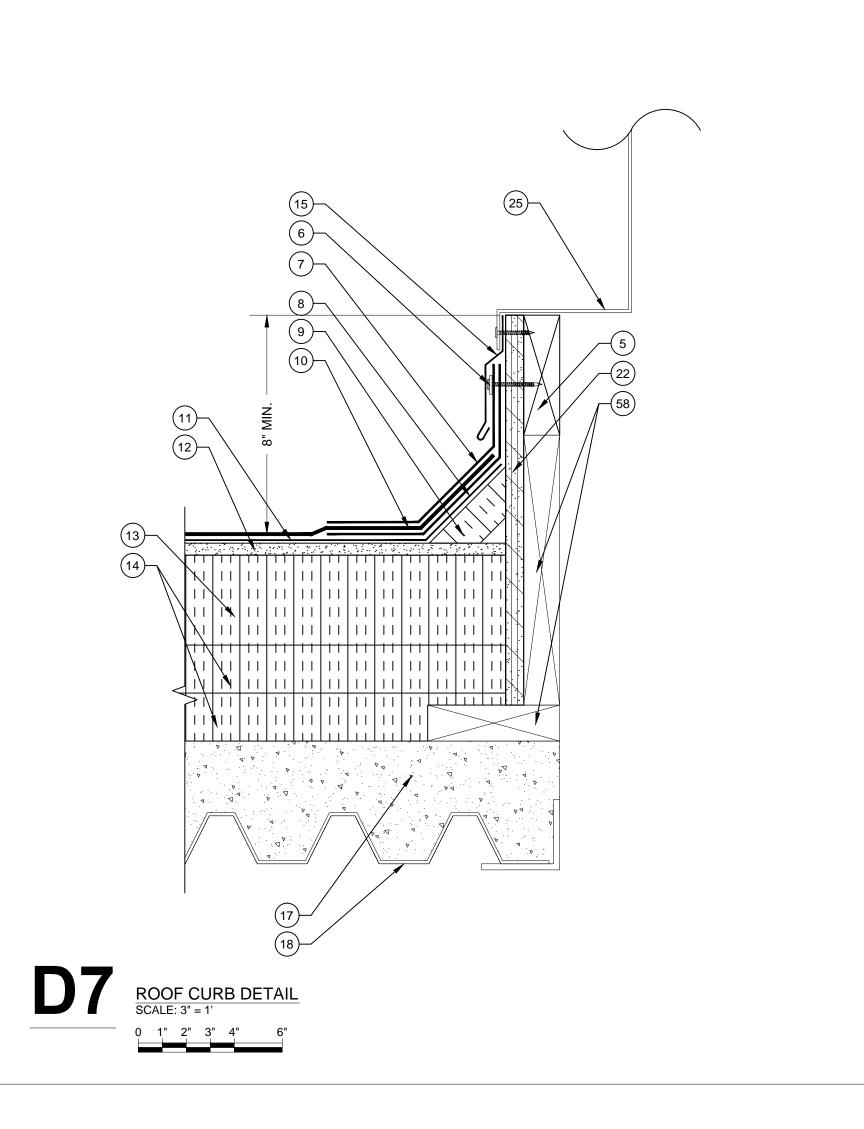

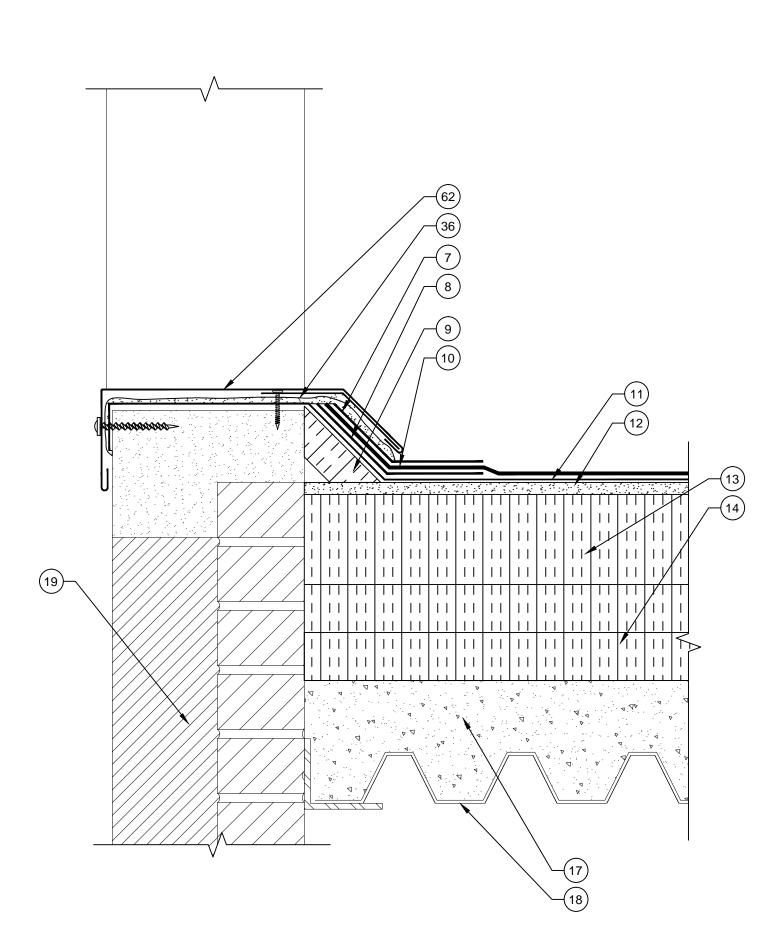

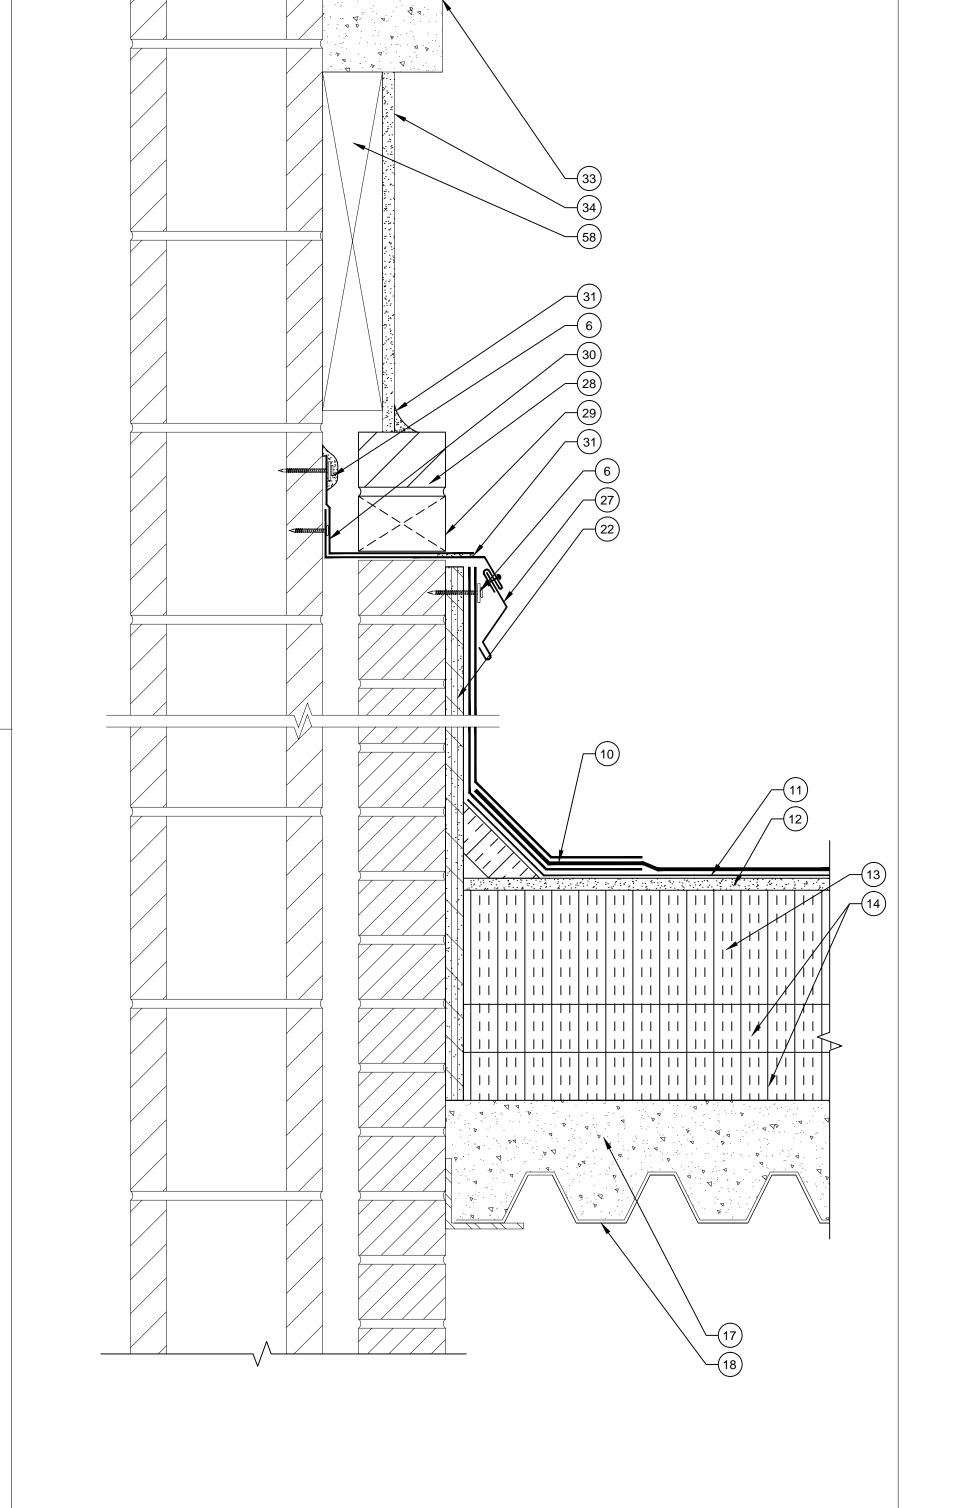

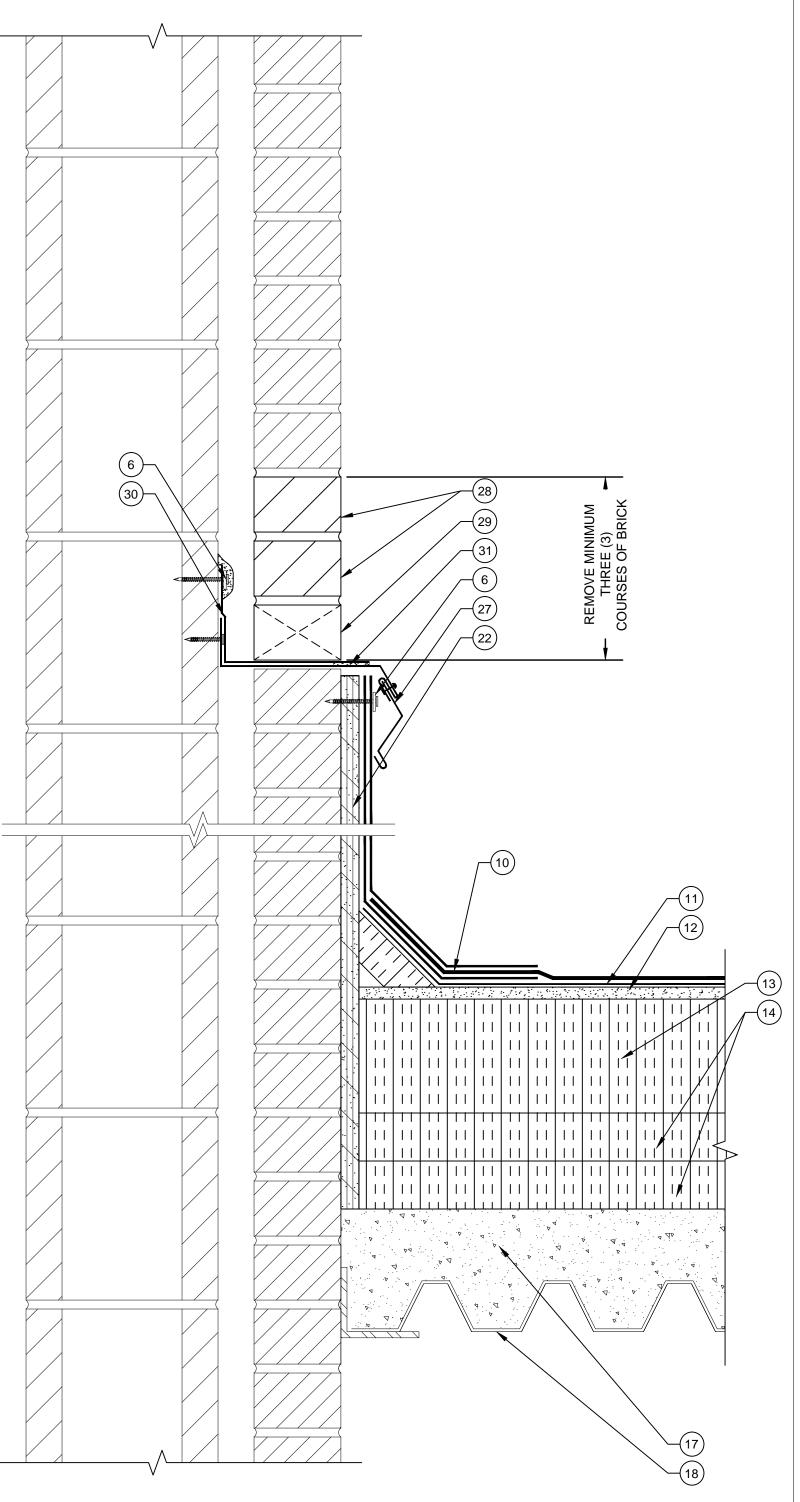

LEGEND

- 1. NEW TWO PIECE COPING CAP
- WITH CONTINUOUS CLEAT 2. NEW SELF- ADHERING
- MEMBRANE NEW STRIPPING PLY
- 4. NEW TAPERED EDGE STRIP
- 5. NEW WOOD BLOCKING 6. NEW TERMINATION BAR AND
- SEALANT
- 7. NEW BASE FLASHING
- 8. NEW BACKER PLY
- NEW CANT STRIP NEW CAP SHEET
- 11. NEW BASE PLY 12. NEW COVER BOARD 13. NEW TAPERED INSULATION
- 14. NEW BASE INSULATION (2) 2" LAYERS
- 15. NEW METAL COUNTER FLASHING 16. THREADED ROD WITH EPOXY
- 17. EXISTING CONCRETE DECK
- 18. EXISTING METAL DECK 19. EXISTING BUILDING STRUCTURE
- 20. NEW METAL WALL PANEL
- 21. NEW HAT CHANNEL 22. NEW PLYWOOD
- 23. NEW METAL COPING CAP WITH CONTINUOUS CLEAT
- 24. EXISTING CURB (WITH BULIT-IN
- 25. EXISTING CURB COVER 26. EXISTING ROOF HATCH 27. NEW STAINLESS STEEL
- COUNTER FLASHING WITH RECEIVER

28. NEW BRICK (TO MATCH

- EXISTING) 29. NEW WEEPS (OMIT MORTAR AT
- HEAD JOINTS) 30. NEW FLEXIBLE COPPER
- FLASHING 31. NEW SEALANT
- 32. NEW STAINLESS STEEL COUNTER FLASHING IN NEW REGLET, LEAD WEDGE AND
- SEALANT 33. EXISTING PRECAST PANEL 34. EXISTING STUCCO
- 35. EXISTING FLASHING 36. NEW LIQUID APPLIED FLASHING
- WITH REINFORCEMENT 37. EXISTING CONCRETE CAP
- 38. EXISTING CONCRETE CURB 39. EXISTING I-BEAM
- 40. EXISTING CONCRETE STRUCTURE
- 41. NEW SURFACE MOUNTED
- COUNTER FLASHING 42. NEW SLEEPER COVER
- 43. EXISTING METAL SLEEPER
- 44. NEW PIPE CAP 45. NEW ROOF DRAIN
- 46. NEW DRAIN EXTENSION 47. NEW DRAIN SUMP
- 48. EXISTING PIPE PENETRATION 49. NEW INSULATION INFILL
- 50. NEW STAIR STRINGER 51. NEW OVERFLOW SCUPPER
- 52. NEW METAL FACE PLATE
- 53. NEW LEAD FLASHING 54. NEW WATER-TIGHT MASTIC
- 55. NEW EXPANSION JOINT COVER 56. NEW BATT INSULATION IN
- POLYETHYLENE ENVELOPE 57. NEW METAL CAP COVER
- 58. EXISTING WOOD BLOCKING
- 59. FASTENERS WITH NEOPRENE WASHERS
- 60. NEW WALK PADS 61. NEW FORM CLOSURE
- 62. NEW DOOR SILL FLASHING
- 63. NEW WOOD FRAMING 64. EXISTING GOOSE NECK
- 65. NEW METAL DECK PAINTED ON INTERIOR TO MATCH EXISTING
- 66. NEW MIDSPAN SUPPORT 67. NEW 2" x3" 20 ga. CLIPS (4)
- 68. NEW $\frac{3}{4}$ " CONCRETE LAG
- 69. EXISTING PLYWOOD 70. NEW BATT INSULATION
- 71. NEW $\frac{1}{4}$ " STEEL Z ANGLE 72. NEW METAL DECKING
- 73. NEW CONCRETE CURB 74. EXISTING CONCRETE CURB
- 75. PRE-MANUFACTURED SLEEPER 76. EXISTING PRE CAST CONCRETE (BEYOND)
- 77. NEW BRACKET
- 78. NEW COPING CAP WITH
- CONTINUOUS CLEAT 79. EXISTING VENTILATION DUCT

STAFFORD CONSULTING ENGINEERS A**Terracon** COMPANY Building Enclosure Systems Specialists

2020 STARITA ROAD SUITE-E


CHARLOTTE, NORTH CAROLINA p: 704.594.8940 f: 704.509.1888

RALEIGH . CHARLOTTE . JACKSONVILLE

PROJECT NAME AND ADDRESS:

S JONES PSC REPLACEMENT PROJECT USC OOF I

ENGINEER STATE LICENSE SEAL

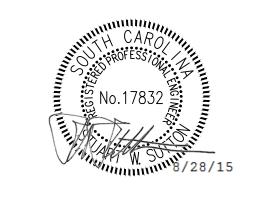

ISSUE DATE:

ISSUE FOR:

AUGUST 28, 2015

- DESIGN DEVELOPMENT SUBMITTAL: NOT FOR CONSTRUCTION
- ☐ SURVEY REPORT SUBMITTAL: NOT FOR CONSTRUCTION
- ☐ CONSTRUCTION DOCUMENT SUBMITTAL: NOT FOR CONSTRUCTION
- BID DOCUMENT SET
- ☐ CONSTRUCTION DOCUMENT SUBMITTAL
- ☐ ADDENDUM SUBMITTAL
- ☐ RECORD DRAWINGS

PROJECT TEAM:

DESIGNED BY: KRC

DRAWN BY:

EGM II

APPROVED BY: VTN


PROJECT NUMBER:


FH146903

REVISIONS: No.: DATE: DESCRIPTION: No.1 06.01.15 ADDENDUM No.1


TITLE SHEET: **ROOF DETAILS**


SHEET NUMBER:

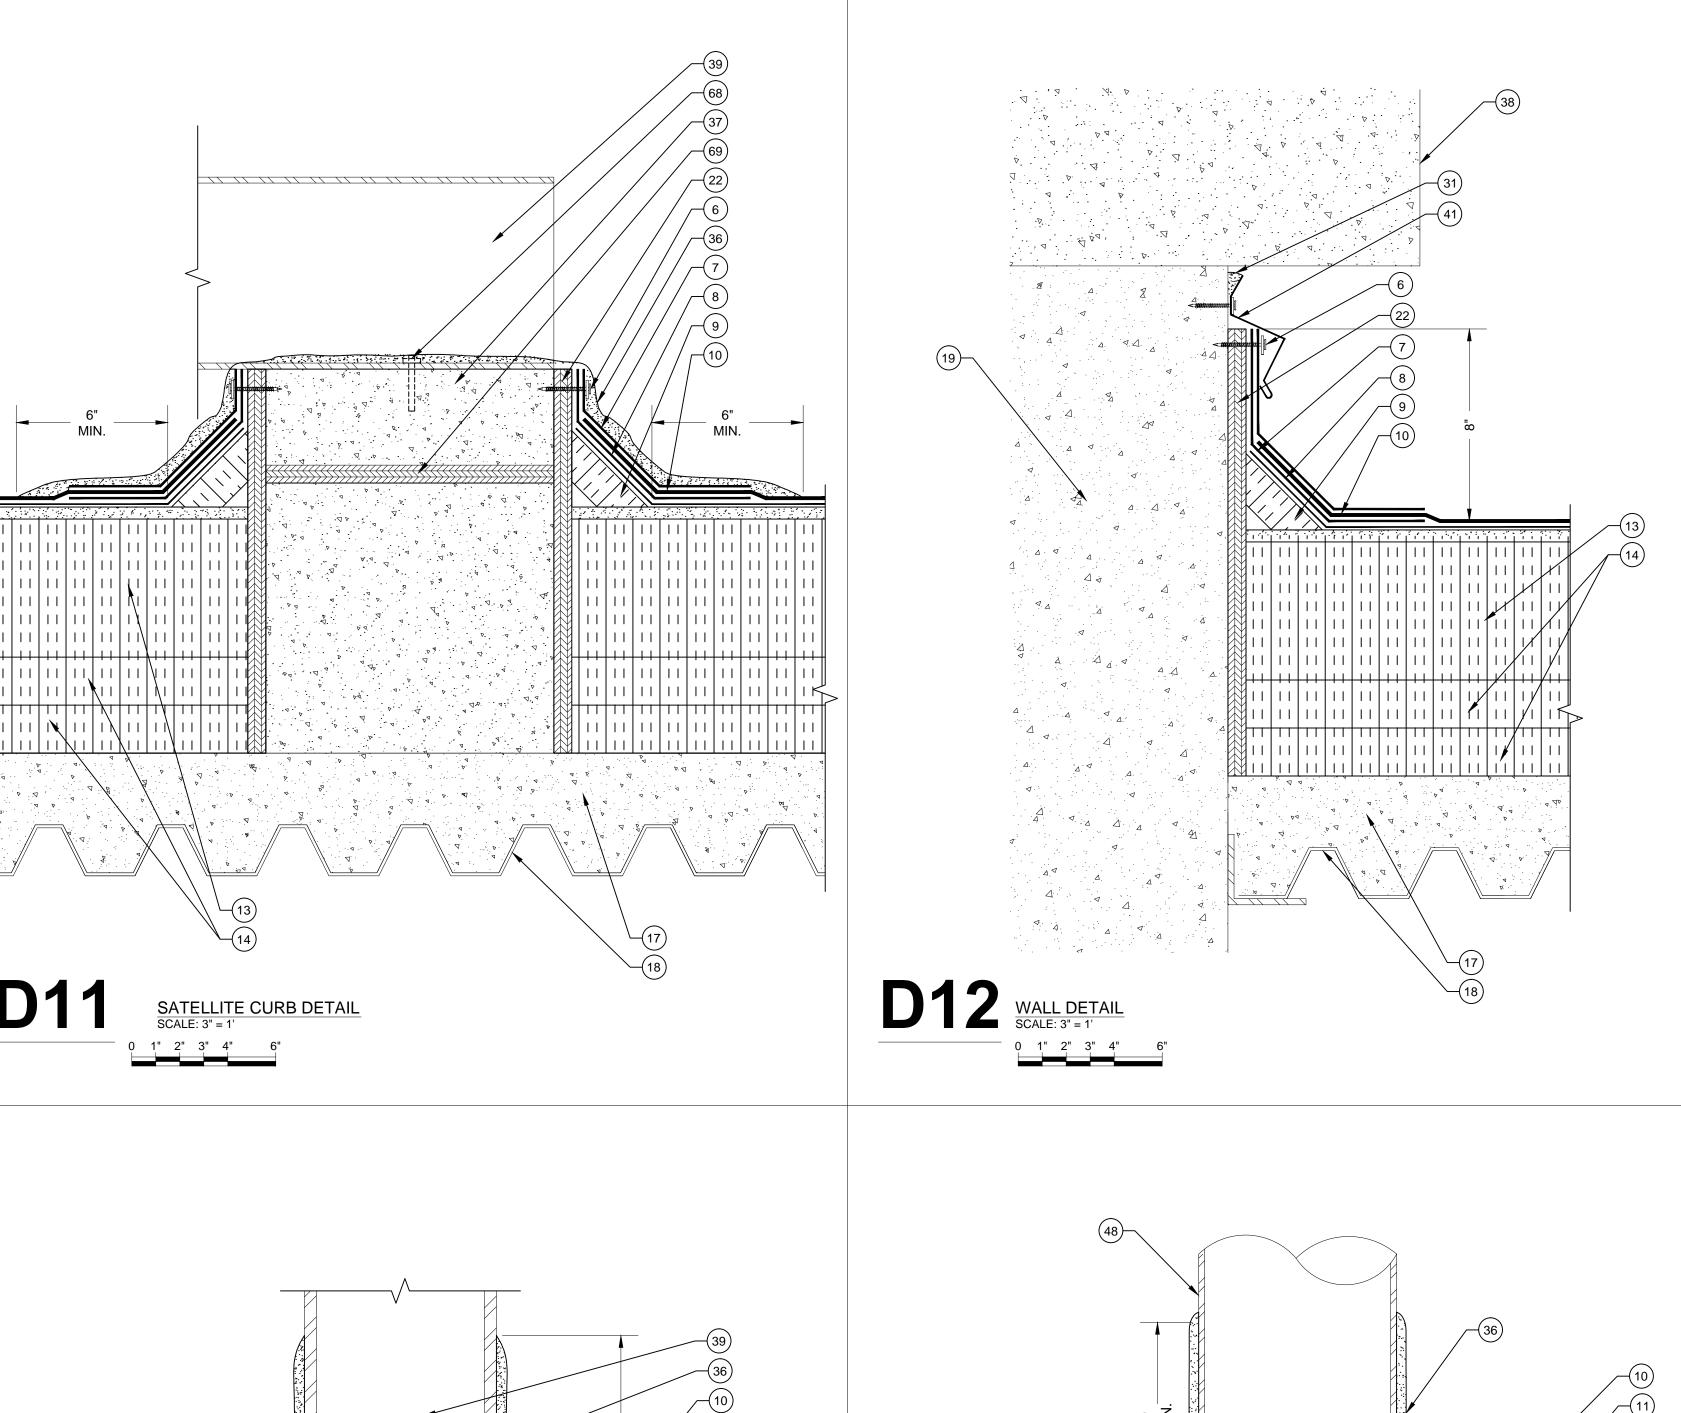

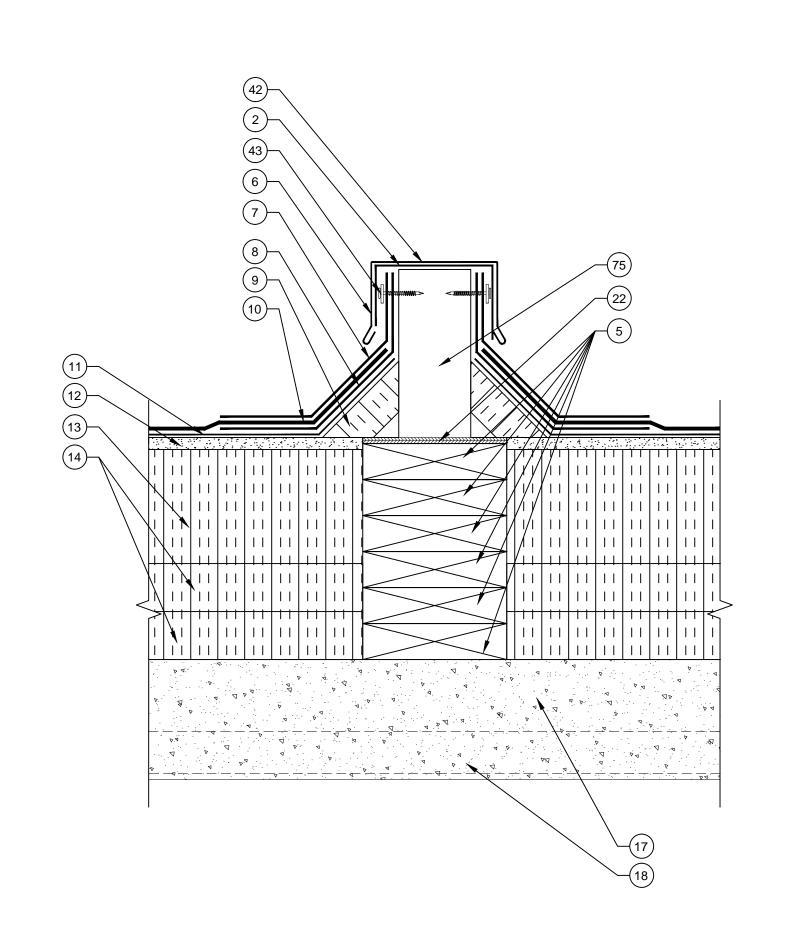

D13 UPPER ROOF SLEEPER DETAIL SCALE: 3" = 1'

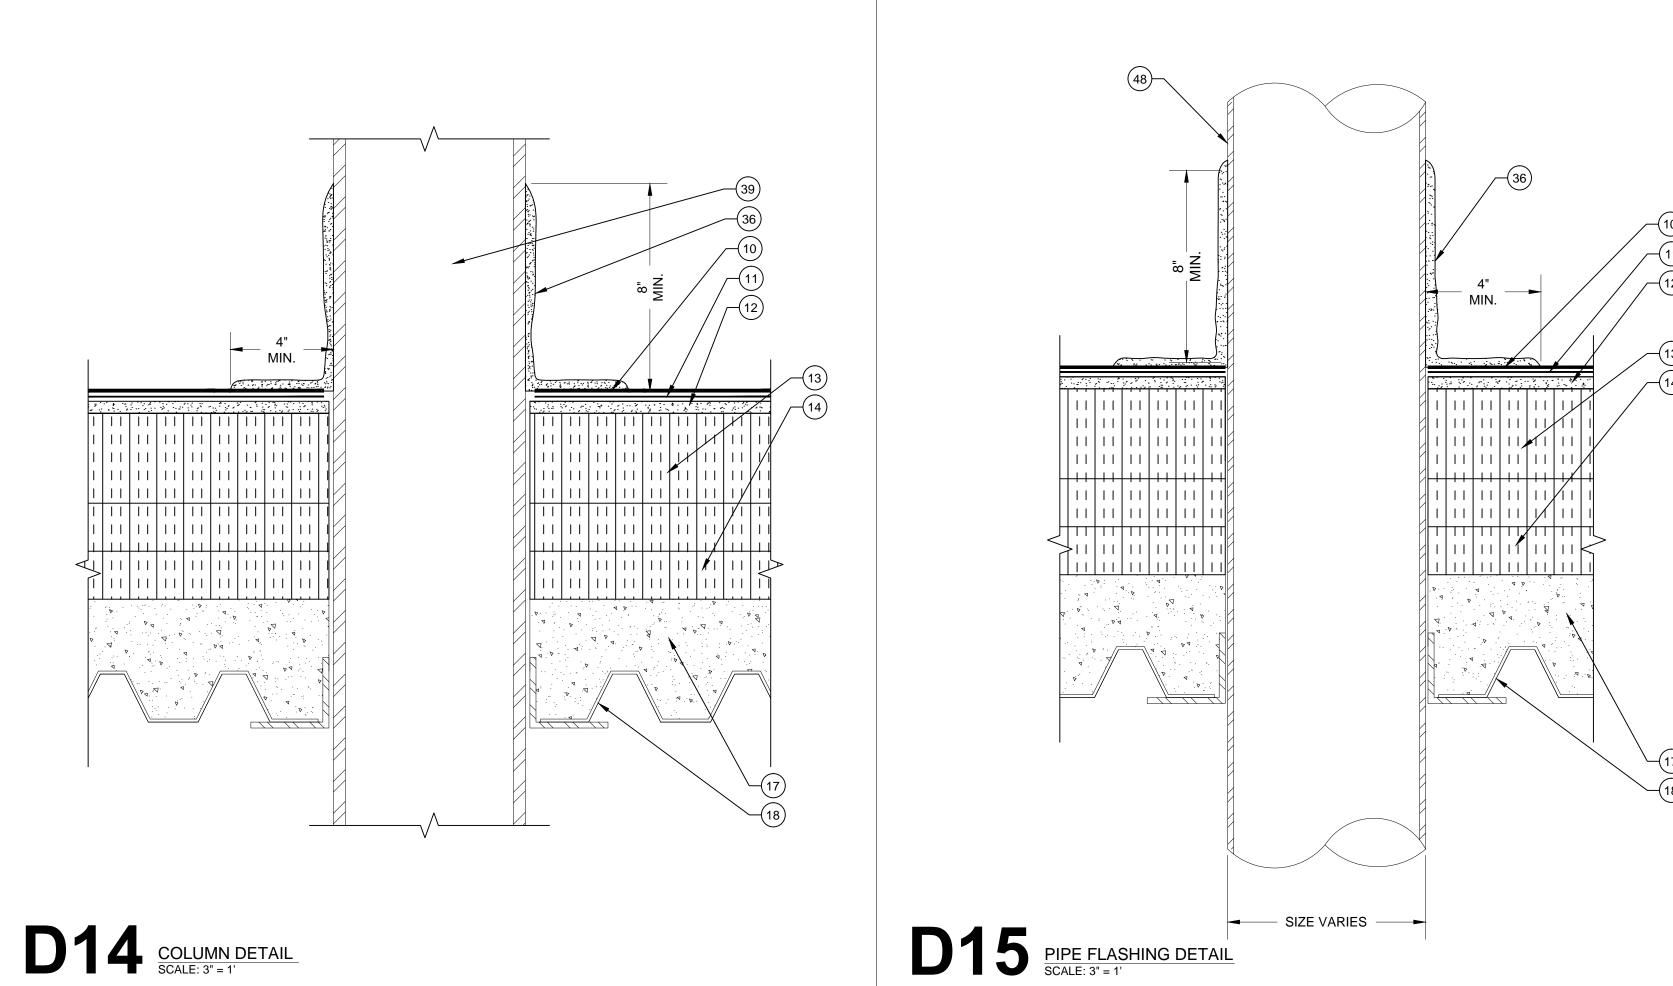

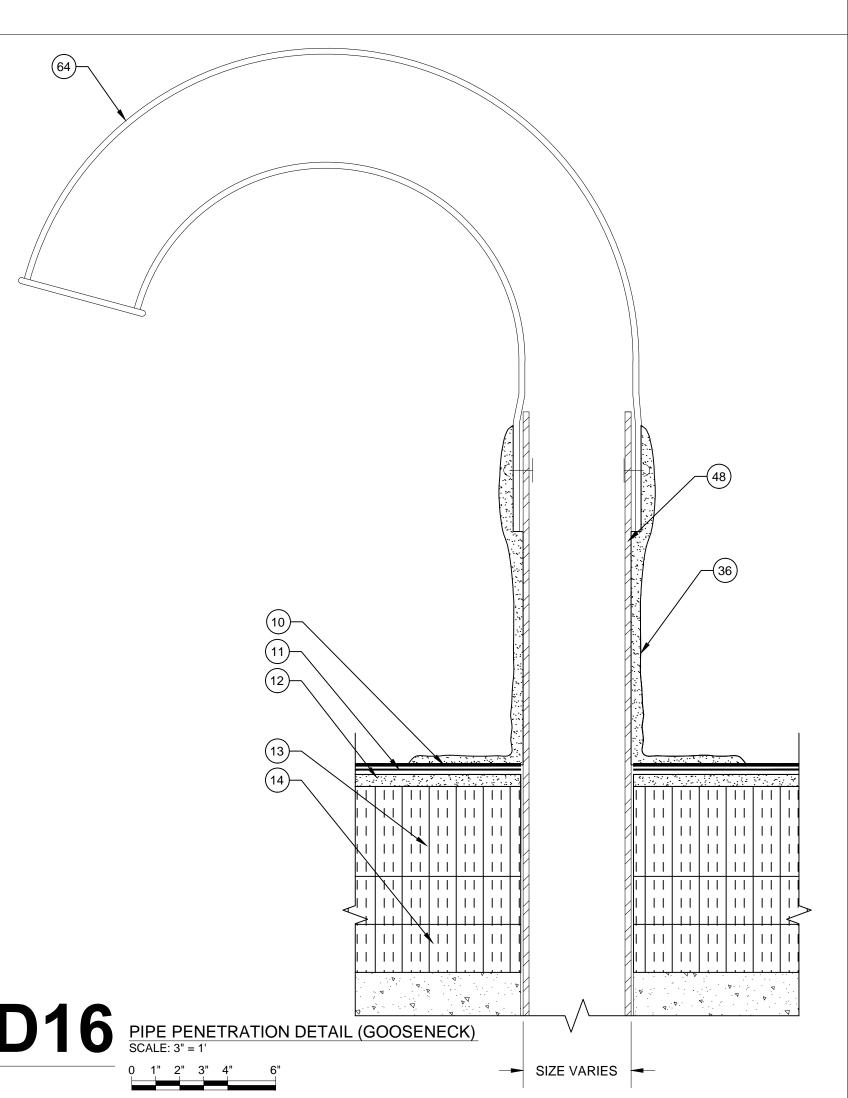

LEGEND

- 1. NEW TWO PIECE COPING CAP
- WITH CONTINUOUS CLEAT NEW SELF- ADHERING
- MEMBRANE
- 3. NEW STRIPPING PLY 4. NEW TAPERED EDGE STRIP
- 5. NEW WOOD BLOCKING 6. NEW TERMINATION BAR AND
- SEALANT
- 7. NEW BASE FLASHING 8. NEW BACKER PLY
- 9. NEW CANT STRIP 10. NEW CAP SHEET
- 11. NEW BASE PLY 12. NEW COVER BOARD
- 13. NEW TAPERED INSULATION 14. NEW BASE INSULATION (2) 2" LAYERS
- 15. NEW METAL COUNTER FLASHING 16. THREADED ROD WITH EPOXY
- 17. EXISTING CONCRETE DECK
- 18. EXISTING METAL DECK
- 19. EXISTING BUILDING STRUCTURE 20. NEW METAL WALL PANEL
- 21. NEW HAT CHANNEL 22. NEW PLYWOOD
- 23. NEW METAL COPING CAP WITH CONTINUOUS CLEAT

24. EXISTING CURB (WITH BULIT-IN

- CANT) 25. EXISTING CURB COVER
- 26. EXISTING ROOF HATCH 27. NEW STAINLESS STEEL
- COUNTER FLASHING WITH RECEIVER 28. NEW BRICK (TO MATCH
- EXISTING) 29. NEW WEEPS (OMIT MORTAR AT
- HEAD JOINTS) 30. NEW FLEXIBLE COPPER FLASHING
- 31. NEW SEALANT 32. NEW STAINLESS STEEL COUNTER FLASHING IN NEW

REGLET, LEAD WEDGE AND

- SEALANT 33. EXISTING PRECAST PANEL 34. EXISTING STUCCO
- 35. EXISTING FLASHING 36. NEW LIQUID APPLIED FLASHING
- WITH REINFORCEMENT 37. EXISTING CONCRETE CAP
- 38. EXISTING CONCRETE CURB 39. EXISTING I-BEAM 40. EXISTING CONCRETE
- STRUCTURE 41. NEW SURFACE MOUNTED
- COUNTER FLASHING
- 42. NEW SLEEPER COVER 43. EXISTING METAL SLEEPER
- 44. NEW PIPE CAP 45. NEW ROOF DRAIN
- 46. NEW DRAIN EXTENSION
- 47. NEW DRAIN SUMP 48. EXISTING PIPE PENETRATION 49. NEW INSULATION INFILL
- 50. NEW STAIR STRINGER 51. NEW OVERFLOW SCUPPER
- 52. NEW METAL FACE PLATE
- 53. NEW LEAD FLASHING 54. NEW WATER-TIGHT MASTIC
- 55. NEW EXPANSION JOINT COVER 56. NEW BATT INSULATION IN
- POLYETHYLENE ENVELOPE 57. NEW METAL CAP COVER
- 58. EXISTING WOOD BLOCKING 59. FASTENERS WITH NEOPRENE
- WASHERS
- 60. NEW WALK PADS
- 61. NEW FORM CLOSURE
- 62. NEW DOOR SILL FLASHING 63. NEW WOOD FRAMING
- 64. EXISTING GOOSE NECK 65. NEW METAL DECK PAINTED ON
- INTERIOR TO MATCH EXISTING 66. NEW MIDSPAN SUPPORT
- 67. NEW 2" x3" 20 ga. CLIPS (4) 68. NEW $\frac{3}{4}$ " CONCRETE LAG
- 69. EXISTING PLYWOOD
- 70. NEW BATT INSULATION
- 71. NEW $\frac{1}{4}$ " STEEL Z ANGLE 72. NEW METAL DECKING
- 73. NEW CONCRETE CURB 74. EXISTING CONCRETE CURB 75. PRE-MANUFACTURED SLEEPER
- 76. EXISTING PRE CAST CONCRETE (BEYOND)
- 77. NEW BRACKET 78. NEW COPING CAP WITH
- CONTINUOUS CLEAT
- 79. EXISTING VENTILATION DUCT



A**llerracon** COMPANY Building Enclosure Systems Specialists 2020 STARITA ROAD SUITE-E

> CHARLOTTE, NORTH CAROLINA p: 704.594.8940 f: 704.509.1888

RALEIGH . CHARLOTTE . JACKSONVILLE

PROJECT NAME AND ADDRESS:

C JONES PSC REPLACEMENT PROJECT





ENGINEER STATE LICENSE SEAL



ISSUE DATE:

AUGUST 28, 2015

ISSUE FOR:

- DESIGN DEVELOPMENT SUBMITTAL:
- NOT FOR CONSTRUCTION ☐ SURVEY REPORT SUBMITTAL: NOT FOR CONSTRUCTION
- ☐ CONSTRUCTION DOCUMENT SUBMITTAL:
- NOT FOR CONSTRUCTION
- BID DOCUMENT SET
- ☐ CONSTRUCTION DOCUMENT SUBMITTAL
- ☐ ADDENDUM SUBMITTAL
- ☐ RECORD DRAWINGS

DRAWN BY:

PROJECT TEAM: DESIGNED BY:

KRC

EGM II APPROVED BY:

VTN PROJECT NUMBER:


FH146903


REVISIONS: No.: DATE: DESCRIPTION:

No.1 06.01.15 ADDENDUM No.1

TITLE SHEET: **ROOF DETAILS**

SHEET NUMBER:

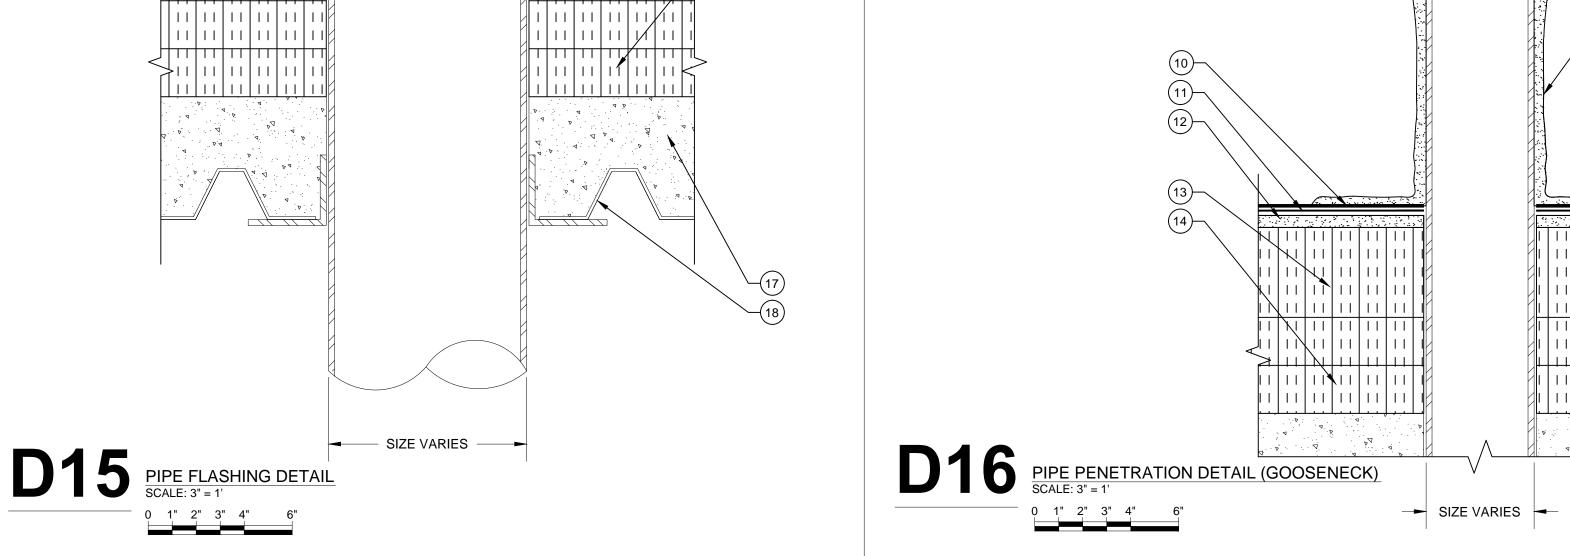

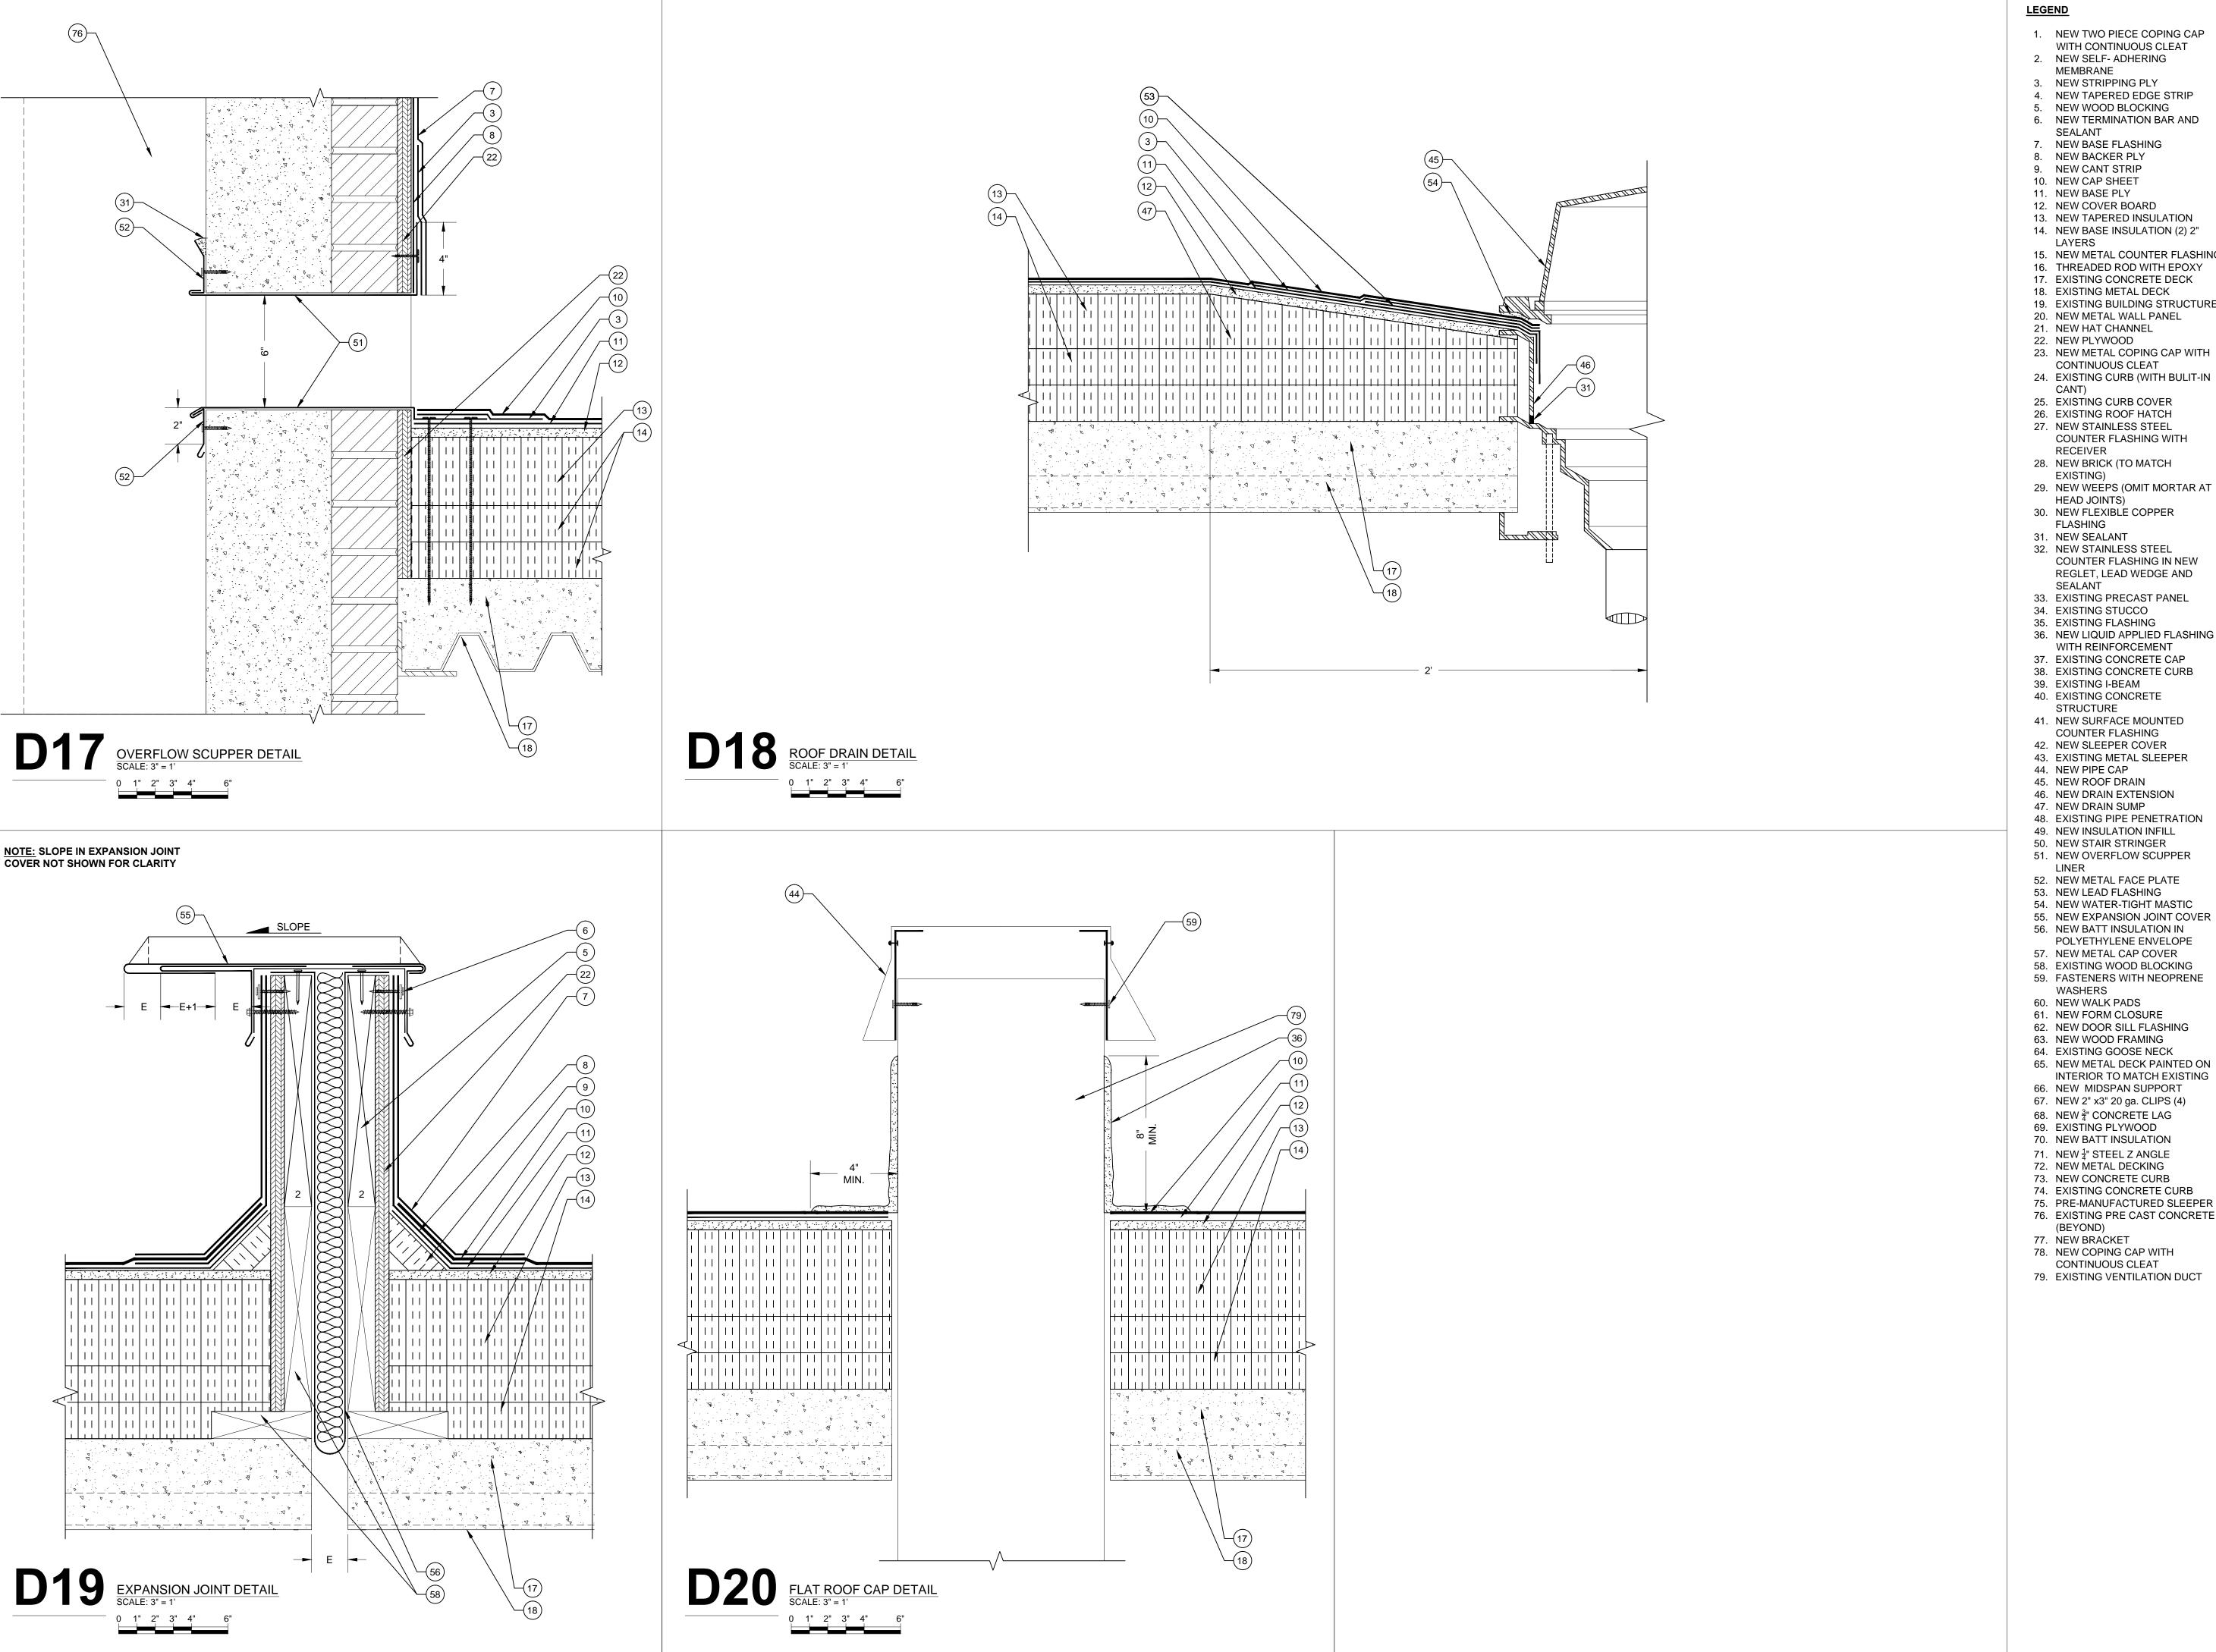

1. NEW TWO PIECE COPING CAP

STAFFORD

Building Enclosure Systems Specialists

2020 STARITA ROAD SUITE-E

CHARLOTTE, NORTH CAROLINA

p: 704.594.8940 f: 704.509.1888

CONSULTING

ENGINEERS

A**llerracon** COMPANY

- WITH CONTINUOUS CLEAT 2. NEW SELF- ADHERING
- **MEMBRANE**
- 3. NEW STRIPPING PLY 4. NEW TAPERED EDGE STRIP
- NEW WOOD BLOCKING
- 6. NEW TERMINATION BAR AND SEALANT
- 7. NEW BASE FLASHING
- 8. NEW BACKER PLY
- 10. NEW CAP SHEET
- 12. NEW COVER BOARD

- 17. EXISTING CONCRETE DECK
- 18. EXISTING METAL DECK
- 21. NEW HAT CHANNEL
- 24. EXISTING CURB (WITH BULIT-IN
- 25. EXISTING CURB COVER
- 27. NEW STAINLESS STEEL
- 28. NEW BRICK (TO MATCH
- HEAD JOINTS)
- 32. NEW STAINLESS STEEL COUNTER FLASHING IN NEW REGLET, LEAD WEDGE AND

- 38. EXISTING CONCRETE CURB
- 40. EXISTING CONCRETE

- 45. NEW ROOF DRAIN
- 47. NEW DRAIN SUMP
- 49. NEW INSULATION INFILL
- 53. NEW LEAD FLASHING
- 54. NEW WATER-TIGHT MASTIC
- 58. EXISTING WOOD BLOCKING
- 59. FASTENERS WITH NEOPRENE
- WASHERS
- 60. NEW WALK PADS
- 61. NEW FORM CLOSURE
- 63. NEW WOOD FRAMING 64. EXISTING GOOSE NECK
- INTERIOR TO MATCH EXISTING 66. NEW MIDSPAN SUPPORT
- 67. NEW 2" x3" 20 ga. CLIPS (4)
- 68. NEW $\frac{3}{4}$ CONCRETE LAG 69. EXISTING PLYWOOD
- 70. NEW BATT INSULATION
- 71. NEW $\frac{1}{4}$ " STEEL Z ANGLE 72. NEW METAL DECKING
- 73. NEW CONCRETE CURB 74. EXISTING CONCRETE CURB
- 75. PRE-MANUFACTURED SLEEPER 76. EXISTING PRE CAST CONCRETE
- (BEYOND) 77. NEW BRACKET
- 78. NEW COPING CAP WITH
- CONTINUOUS CLEAT
- 79. EXISTING VENTILATION DUCT
- No.: DATE: DESCRIPTION:

PROJECT TEAM:


DESIGNED BY:

DRAWN BY:

APPROVED BY:

REVISIONS:

PROJECT NUMBER:

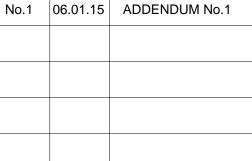

KRC

EGM II


VTN


FH146903

TITLE SHEET:


ROOF DETAILS

SHEET NUMBER:

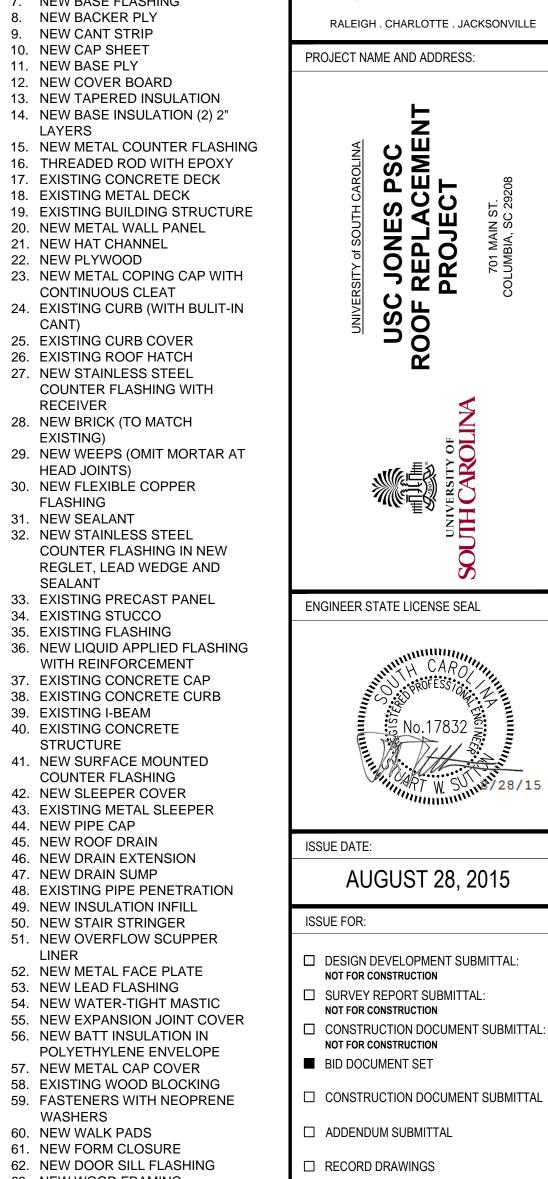


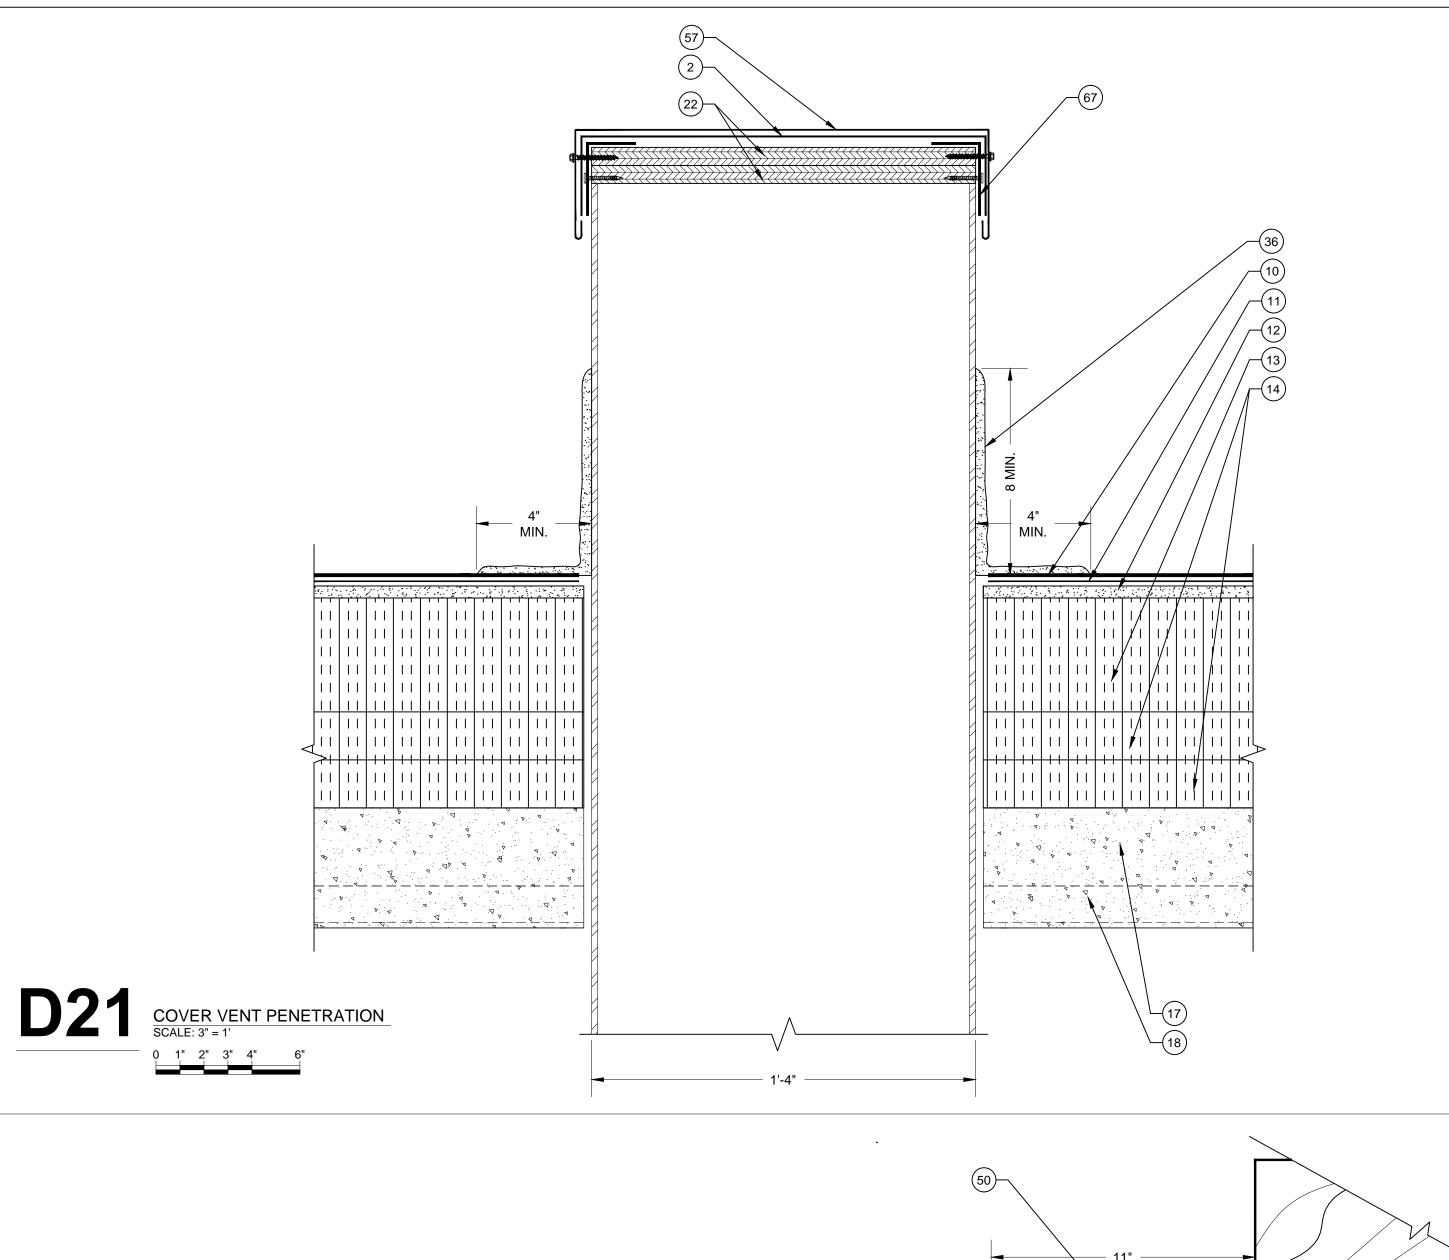


D23 NEW STAIR DETAIL SCALE: 3" = 1'

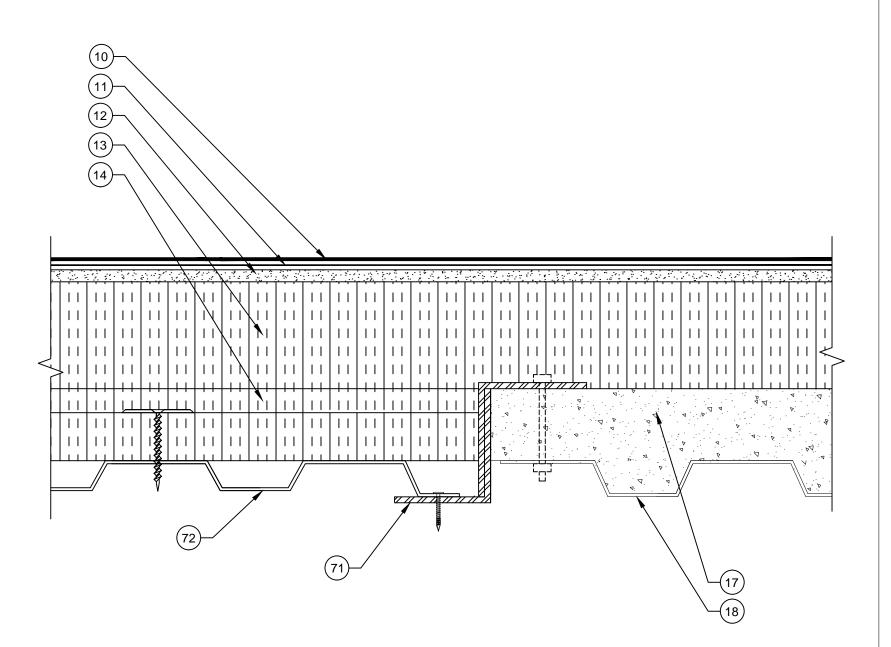

22 ABANDONED SKYLIGHT CURB DETAIL SCALE: 3" = 1'

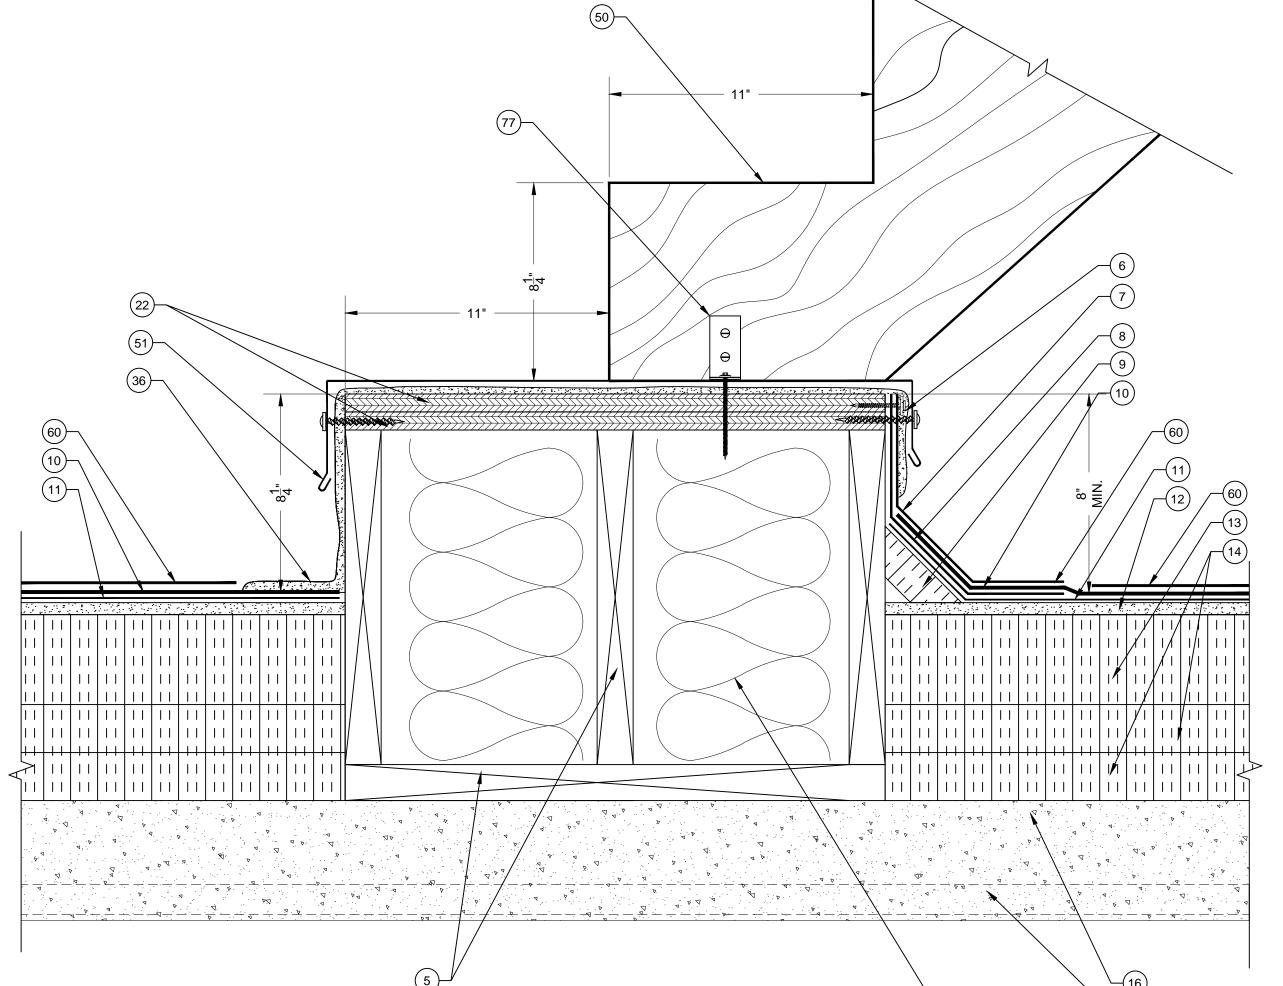

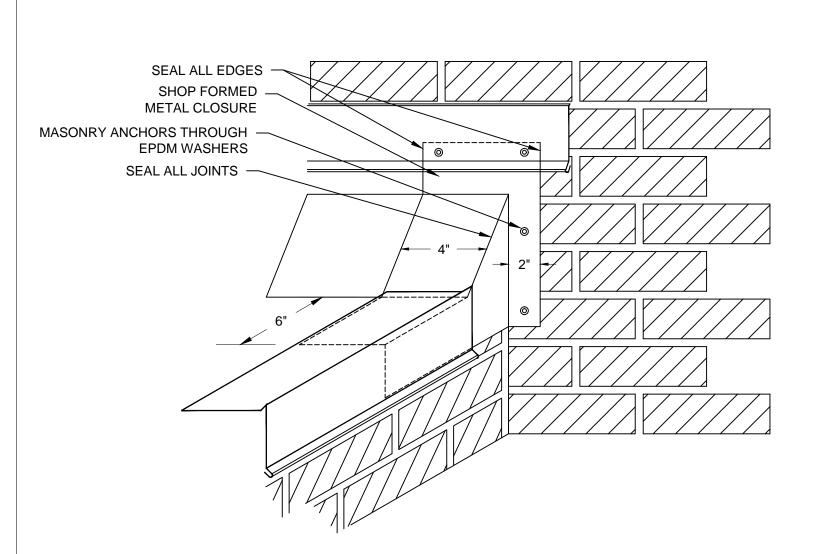

NOTE: BASE FLASHINGS, INSULATION, ETC. NOT SHOWN FOR CLARITY

D24 BASE CLOSURE DETAIL SCALE: NTS

- 1. NEW TWO PIECE COPING CAP
- WITH CONTINUOUS CLEAT 2. NEW SELF- ADHERING
- MEMBRANE 3. NEW STRIPPING PLY
- 4. NEW TAPERED EDGE STRIP
- 5. NEW WOOD BLOCKING 6. NEW TERMINATION BAR AND
- SEALANT 7. NEW BASE FLASHING
- 8. NEW BACKER PLY 9. NEW CANT STRIP
- 10. NEW CAP SHEET 11. NEW BASE PLY
- 12. NEW COVER BOARD 13. NEW TAPERED INSULATION 14. NEW BASE INSULATION (2) 2"
- LAYERS 15. NEW METAL COUNTER FLASHING
- 16. THREADED ROD WITH EPOXY
- 17. EXISTING CONCRETE DECK
- 18. EXISTING METAL DECK
- 19. EXISTING BUILDING STRUCTURE
- 20. NEW METAL WALL PANEL 21. NEW HAT CHANNEL
- 22. NEW PLYWOOD 23. NEW METAL COPING CAP WITH CONTINUOUS CLEAT
- 24. EXISTING CURB (WITH BULIT-IN CANT)
- 25. EXISTING CURB COVER 26. EXISTING ROOF HATCH
- 27. NEW STAINLESS STEEL COUNTER FLASHING WITH
- RECEIVER 28. NEW BRICK (TO MATCH
- EXISTING) 29. NEW WEEPS (OMIT MORTAR AT
- **HEAD JOINTS)** 30. NEW FLEXIBLE COPPER
- FLASHING 31. NEW SEALANT
- 32. NEW STAINLESS STEEL COUNTER FLASHING IN NEW REGLET, LEAD WEDGE AND SEALANT
- 33. EXISTING PRECAST PANEL 34. EXISTING STUCCO
- 35. EXISTING FLASHING
- 36. NEW LIQUID APPLIED FLASHING WITH REINFORCEMENT
- 37. EXISTING CONCRETE CAP 38. EXISTING CONCRETE CURB
- 39. EXISTING I-BEAM
- 40. EXISTING CONCRETE
- STRUCTURE 41. NEW SURFACE MOUNTED
- COUNTER FLASHING 42. NEW SLEEPER COVER
- 43. EXISTING METAL SLEEPER
- 44. NEW PIPE CAP
- 45. NEW ROOF DRAIN
- 46. NEW DRAIN EXTENSION 47. NEW DRAIN SUMP
- 48. EXISTING PIPE PENETRATION 49. NEW INSULATION INFILL
- 50. NEW STAIR STRINGER 51. NEW OVERFLOW SCUPPER
- LINER 52. NEW METAL FACE PLATE
- 53. NEW LEAD FLASHING 54. NEW WATER-TIGHT MASTIC
- 55. NEW EXPANSION JOINT COVER 56. NEW BATT INSULATION IN
- POLYETHYLENE ENVELOPE
- 57. NEW METAL CAP COVER
- 58. EXISTING WOOD BLOCKING
- 59. FASTENERS WITH NEOPRENE WASHERS
- 60. NEW WALK PADS
- 61. NEW FORM CLOSURE
- 62. NEW DOOR SILL FLASHING 63. NEW WOOD FRAMING
- 64. EXISTING GOOSE NECK 65. NEW METAL DECK PAINTED ON
- INTERIOR TO MATCH EXISTING
- 66. NEW MIDSPAN SUPPORT 67. NEW 2" x3" 20 ga. CLIPS (4)
- 68. NEW $\frac{3}{4}$ " CONCRETE LAG
- 69. EXISTING PLYWOOD 70. NEW BATT INSULATION
- 71. NEW $\frac{1}{4}$ " STEEL Z ANGLE 72. NEW METAL DECKING
- 74. EXISTING CONCRETE CURB 75. PRE-MANUFACTURED SLEEPER

73. NEW CONCRETE CURB

- 76. EXISTING PRE CAST CONCRETE
- (BEYOND)
- 77. NEW BRACKET 78. NEW COPING CAP WITH
- CONTINUOUS CLEAT
- 79. EXISTING VENTILATION DUCT

STAFFORD CONSULTING **ENGINEERS** A**llerracon** COMPANY

Building Enclosure Systems Specialists 2020 STARITA ROAD SUITE-E

CHARLOTTE, NORTH CAROLINA

p: 704.594.8940 f: 704.509.1888

RALEIGH . CHARLOTTE . JACKSONVILLE

PROJECT NAME AND ADDRESS:

USC JONES PSC ROOF REPLACEMENT PROJECT



ENGINEER STATE LICENSE SEAL



ISSUE DATE:

AUGUST 28, 2015

ISSUE FOR:

DESIGN DEVELOPMENT SUBMITTAL: NOT FOR CONSTRUCTION

- ☐ SURVEY REPORT SUBMITTAL:
- NOT FOR CONSTRUCTION ☐ CONSTRUCTION DOCUMENT SUBMITTAL:
- NOT FOR CONSTRUCTION ■ BID DOCUMENT SET
- ☐ CONSTRUCTION DOCUMENT SUBMITTAL
- ☐ ADDENDUM SUBMITTAL

☐ RECORD DRAWINGS

PROJECT TEAM:

DRAWN BY:

APPROVED BY:

PROJECT NUMBER:

DESIGNED BY: KRC

EGM II

VTN

FH146903


REVISIONS: No.: DATE: DESCRIPTION:


No.1 06.01.15 ADDENDUM No.1

TITLE SHEET:

ROOF DETAILS

SHEET NUMBER:

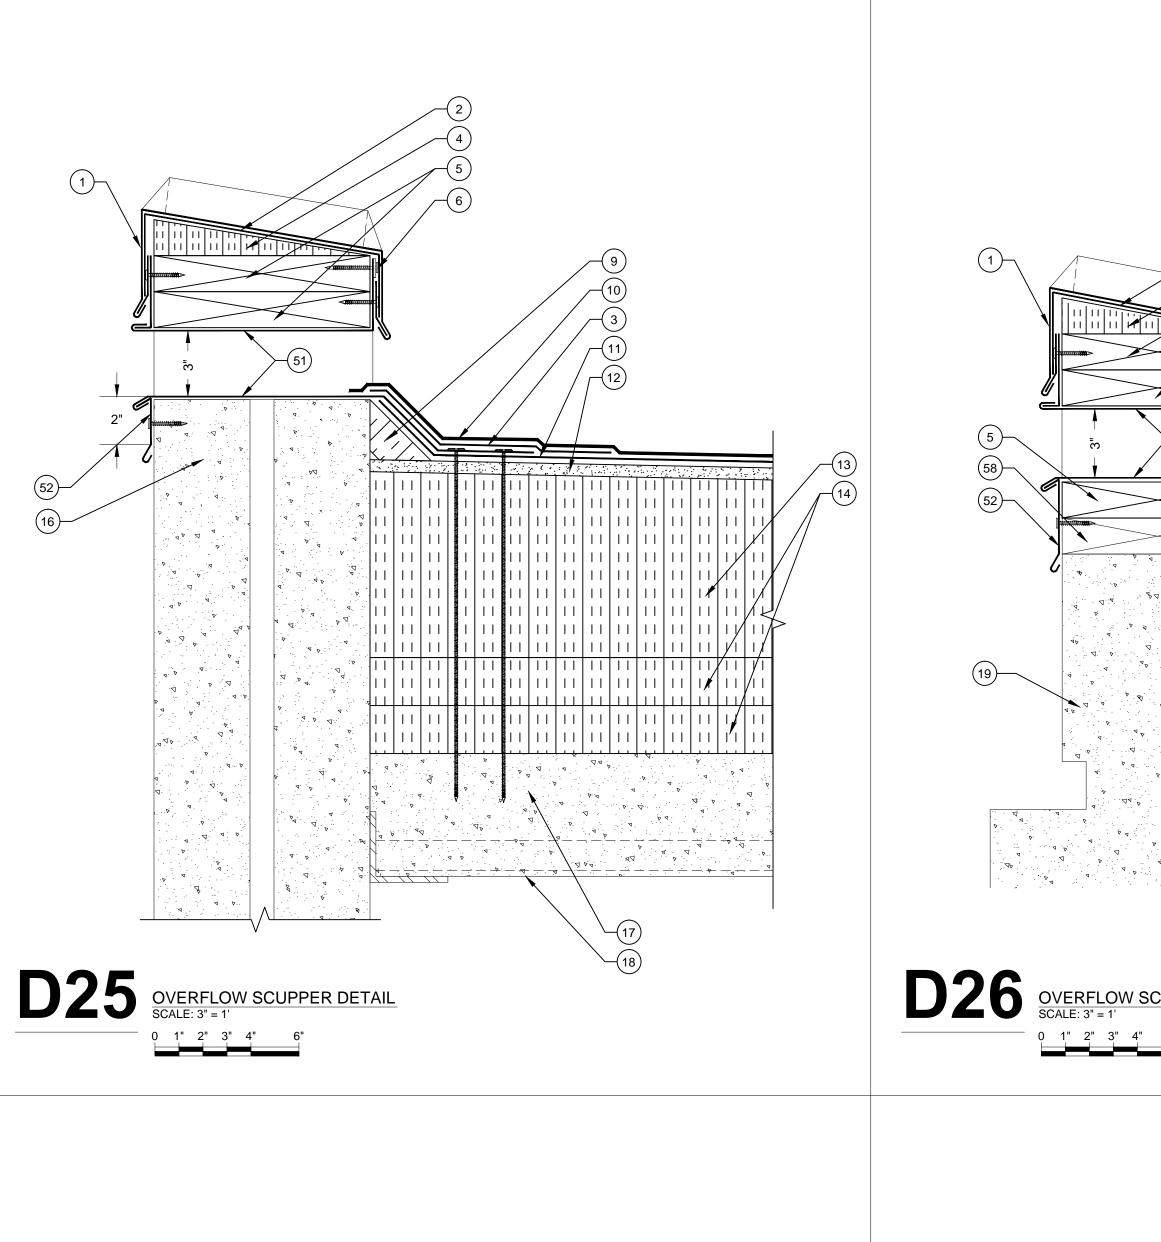

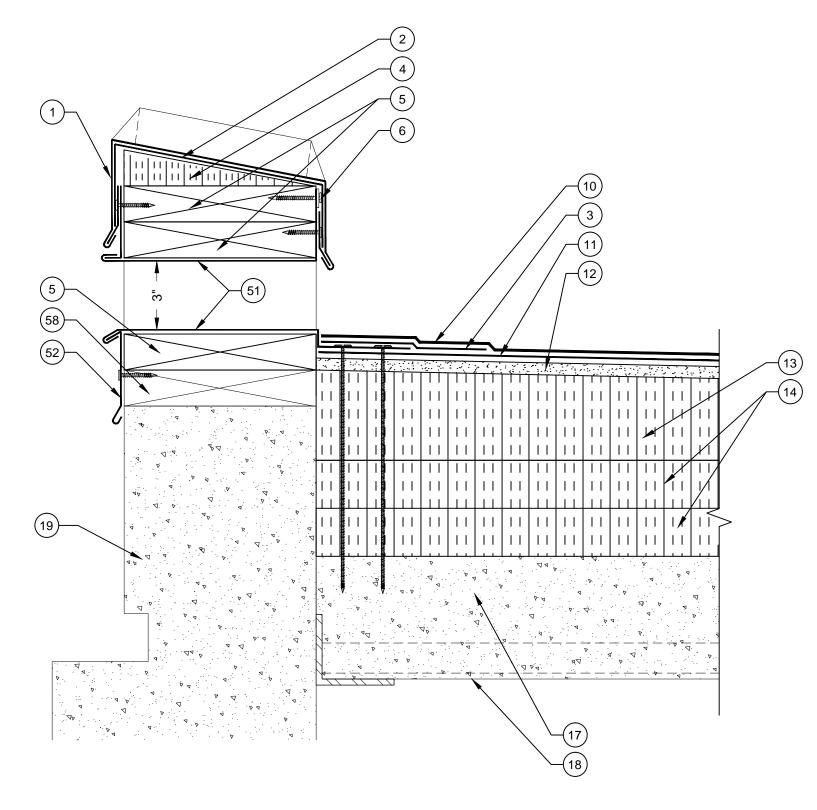

LEGEND

- NEW TWO PIECE COPING CAP
- WITH CONTINUOUS CLEAT 2. NEW SELF- ADHERING
- MEMBRANE 3. NEW STRIPPING PLY
- 4. NEW TAPERED EDGE STRIP
- 5. NEW WOOD BLOCKING
- 6. NEW TERMINATION BAR AND
- SEALANT 7. NEW BASE FLASHING
- 8. NEW BACKER PLY
- 9. NEW CANT STRIP
- 10. NEW CAP SHEET
- 11. NEW BASE PLY 12. NEW COVER BOARD
- 13. NEW TAPERED INSULATION 14. NEW BASE INSULATION (2) 2"
- LAYERS 15. NEW METAL COUNTER FLASHING
- 16. THREADED ROD WITH EPOXY
- 17. EXISTING CONCRETE DECK
- 18. EXISTING METAL DECK
- 19. EXISTING BUILDING STRUCTURE
- 20. NEW METAL WALL PANEL 21. NEW HAT CHANNEL
- 22. NEW PLYWOOD
- 23. NEW METAL COPING CAP WITH
- CONTINUOUS CLEAT 24. EXISTING CURB (WITH BULIT-IN
- 25. EXISTING CURB COVER
- 26. EXISTING ROOF HATCH 27. NEW STAINLESS STEEL COUNTER FLASHING WITH
- RECEIVER 28. NEW BRICK (TO MATCH
- EXISTING) 29. NEW WEEPS (OMIT MORTAR AT
- HEAD JOINTS) 30. NEW FLEXIBLE COPPER
- FLASHING 31. NEW SEALANT

SEALANT

- 32. NEW STAINLESS STEEL COUNTER FLASHING IN NEW REGLET, LEAD WEDGE AND
- 33. EXISTING PRECAST PANEL 34. EXISTING STUCCO
- 35. EXISTING FLASHING
- 36. NEW LIQUID APPLIED FLASHING WITH REINFORCEMENT
- 37. EXISTING CONCRETE CAP
- 38. EXISTING CONCRETE CURB
- 39. EXISTING I-BEAM
- 40. EXISTING CONCRETE STRUCTURE
- 41. NEW SURFACE MOUNTED
- COUNTER FLASHING
- 42. NEW SLEEPER COVER
- 43. EXISTING METAL SLEEPER
- 44. NEW PIPE CAP
- 45. NEW ROOF DRAIN
- 46. NEW DRAIN EXTENSION 47. NEW DRAIN SUMP
- 48. EXISTING PIPE PENETRATION 49. NEW INSULATION INFILL
- 50. NEW STAIR STRINGER 51. NEW OVERFLOW SCUPPER
- LINER
- 52. NEW METAL FACE PLATE 53. NEW LEAD FLASHING
- 54. NEW WATER-TIGHT MASTIC 55. NEW EXPANSION JOINT COVER
- 56. NEW BATT INSULATION IN
- POLYETHYLENE ENVELOPE 57. NEW METAL CAP COVER
- 58. EXISTING WOOD BLOCKING
- 59. FASTENERS WITH NEOPRENE
- WASHERS 60. NEW WALK PADS
- 61. NEW FORM CLOSURE
- 62. NEW DOOR SILL FLASHING 63. NEW WOOD FRAMING
- 64. EXISTING GOOSE NECK 65. NEW METAL DECK PAINTED ON
- INTERIOR TO MATCH EXISTING
- 66. NEW MIDSPAN SUPPORT 67. NEW 2" x3" 20 ga. CLIPS (4)
- 68. NEW $\frac{3}{4}$ " CONCRETE LAG
- 69. EXISTING PLYWOOD 70. NEW BATT INSULATION
- 71. NEW $\frac{1}{4}$ " STEEL Z ANGLE
- 72. NEW METAL DECKING 73. NEW CONCRETE CURB
- 74. EXISTING CONCRETE CURB 75. PRE-MANUFACTURED SLEEPER
- 76. EXISTING PRE CAST CONCRETE (BEYOND)
- 77. NEW BRACKET
- 78. NEW COPING CAP WITH
- CONTINUOUS CLEAT
- 79. EXISTING VENTILATION DUCT



2020 STARITA ROAD SUITE-E CHARLOTTE, NORTH CAROLINA p: 704.594.8940 f: 704.509.1888


RALEIGH . CHARLOTTE . JACKSONVILLE

PROJECT NAME AND ADDRESS:

USC JONES PSC ROOF REPLACEMENT PROJECT



ENGINEER STATE LICENSE SEAL

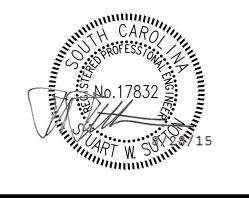

ISSUE DATE:

AUGUST 28, 2015

ISSUE FOR:

- NOT FOR CONSTRUCTION ☐ SURVEY REPORT SUBMITTAL:
 - NOT FOR CONSTRUCTION ☐ CONSTRUCTION DOCUMENT SUBMITTAL:
 - NOT FOR CONSTRUCTION ■ BID DOCUMENT SET
 - ☐ CONSTRUCTION DOCUMENT SUBMITTAL

 - ☐ ADDENDUM SUBMITTAL
 - ☐ RECORD DRAWINGS

DESIGNED BY:

PROJECT TEAM:

KRC

DRAWN BY: EGM II

APPROVED BY:

PROJECT NUMBER:

VTN

FH146903

REVISIONS:

No.: DATE: DESCRIPTION:

No.1 06.01.15 ADDENDUM No.1

TITLE SHEET:

SHEET NUMBER:

ROOF DETAILS




























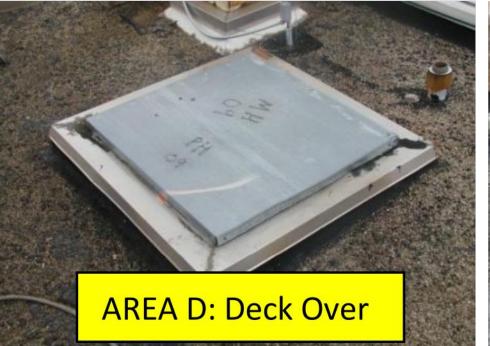





2020 STARITA ROAD SUITE-E CHARLOTTE, NORTH CAROLINA p: 704.594.8940 f: 704.509.1888

RALEIGH . CHARLOTTE . JACKSONVILLE

PROJECT NAME AND ADDRESS:

USC JONES PSC
ROOF REPLACEMEN
PROJECT



ENGINEER STATE LICENSE SEAL



ISSUE DATE:

AUGUST 28, 2015

ISSUE FOR:

- ☐ DESIGN DEVELOPMENT SUBMITTAL: NOT FOR CONSTRUCTION
- ☐ SURVEY REPORT SUBMITTAL:NOT FOR CONSTRUCTION☐ CONSTRUCTION DOCUMENT SUBMITTAL:
- □ CONSTRUCTION DOCUMENT SUBMITTAL: NOT FOR CONSTRUCTION■ BID DOCUMENT SET
- ☐ CONSTRUCTION DOCUMENT SUBMITTAL
- ☐ ADDENDUM SUBMITTAL

☐ RECORD DRAWINGS

PROJECT TEAM:

DESIGNED BY:

DRAWN BY:

EGM II

APPROVED BY:

PROJECT NUMBER:

VTN

FH146903

REVISIONS:

No.1 06.01.15 ADDENDUM No.1

NO.1 U6.01.15 ADDENDUM NO

TITLE SHEET:

REMOVALS

SHEET NUMBER: